

BRIAN J. WENDLING


SAGINAW COUNTY PUBLIC WORKS COMMISSIONER

SMITH DRAIN

PART OF SECTIONS 16, 17, 20, 21, AND 29 OF RICHLAND TOWNSHIP, T12N, R2E, SAGINAW COUNTY, MICHIGAN

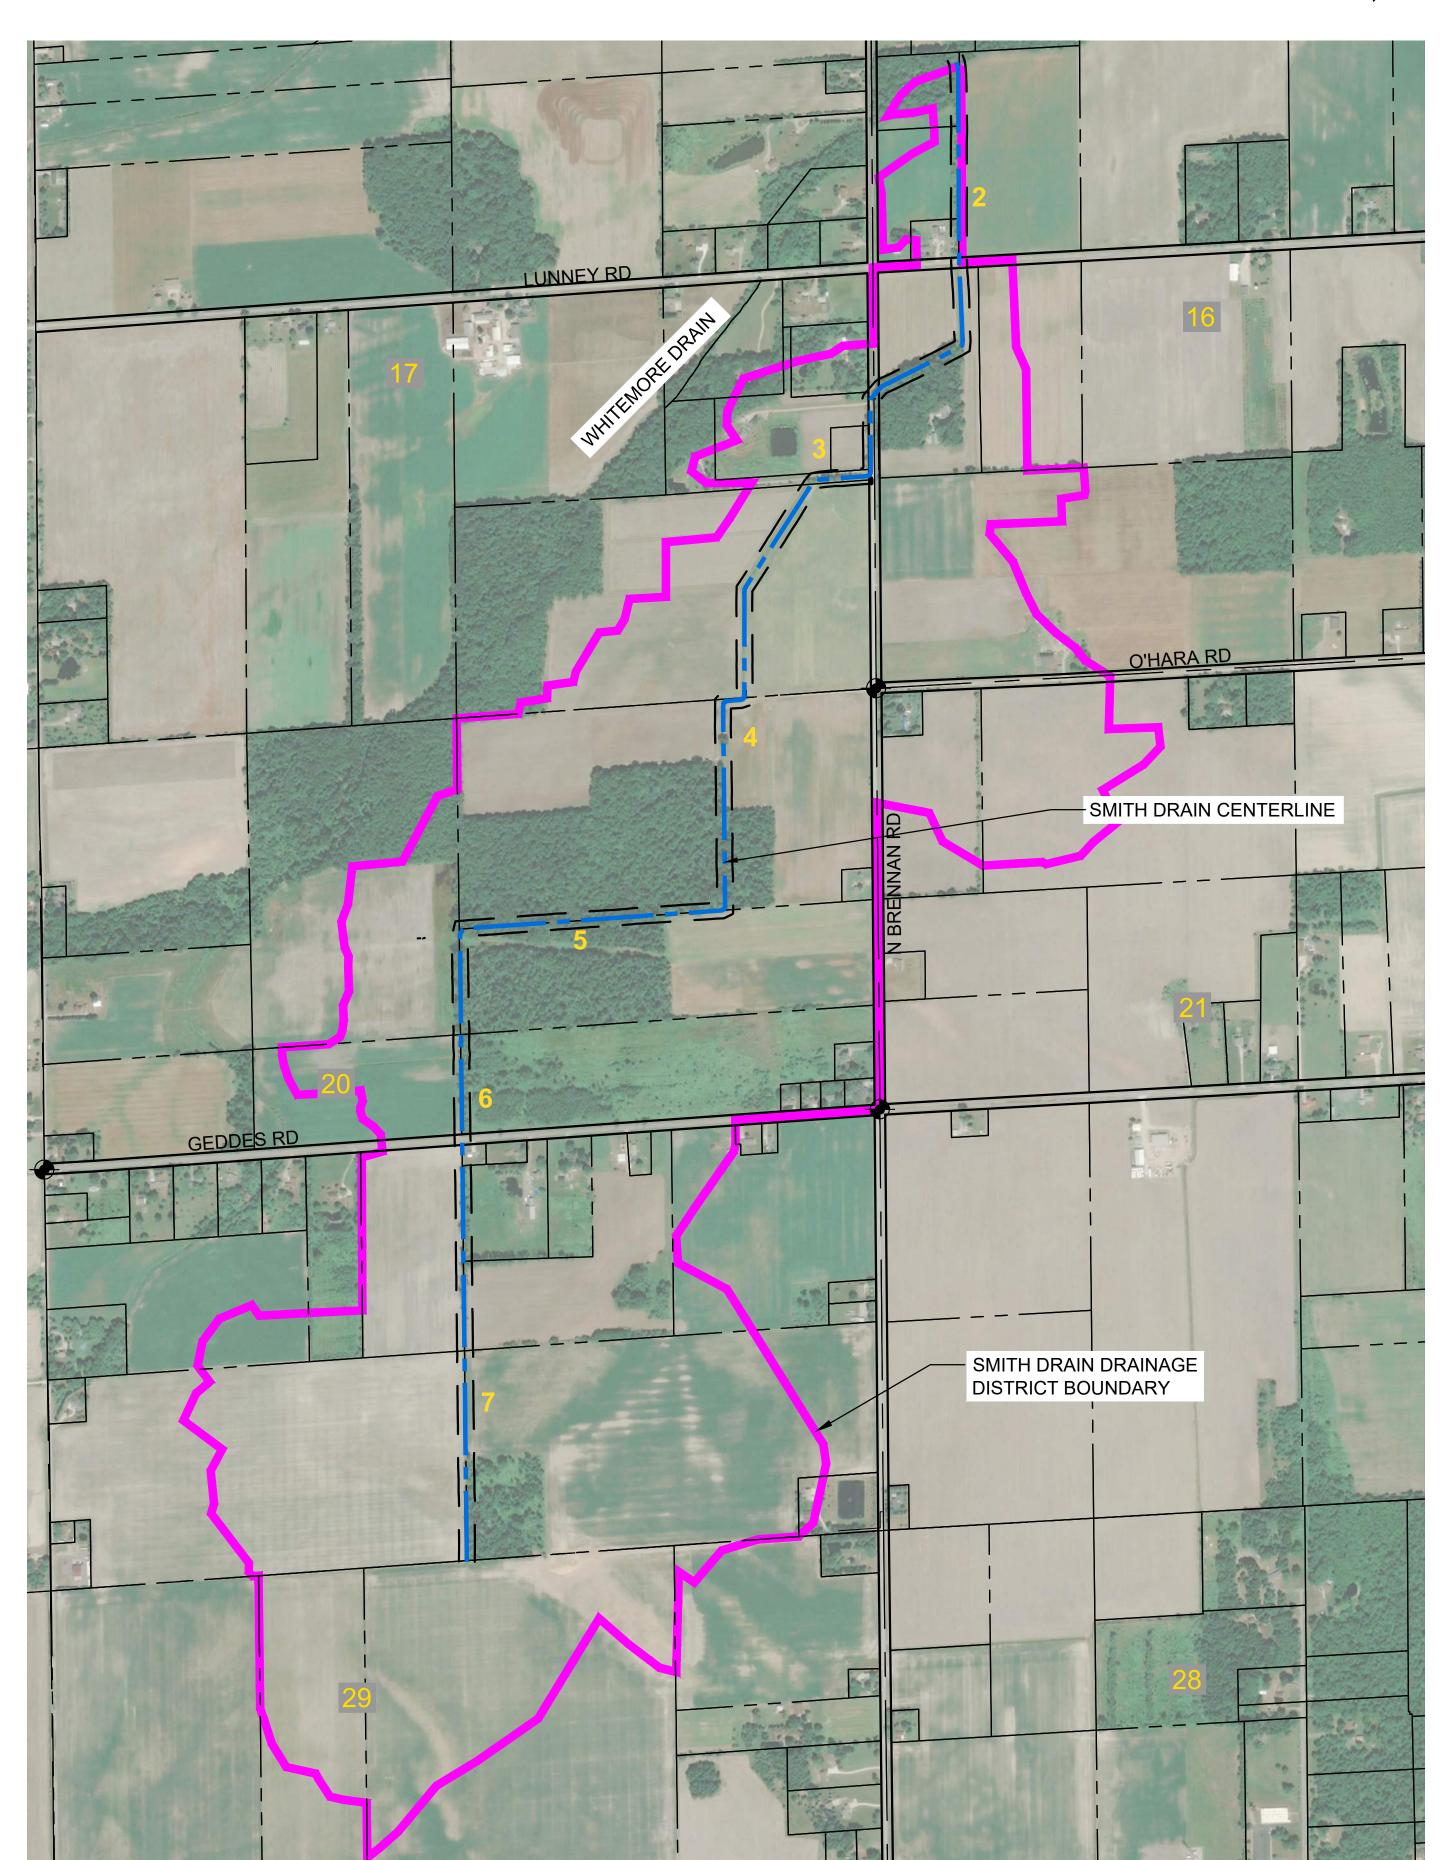

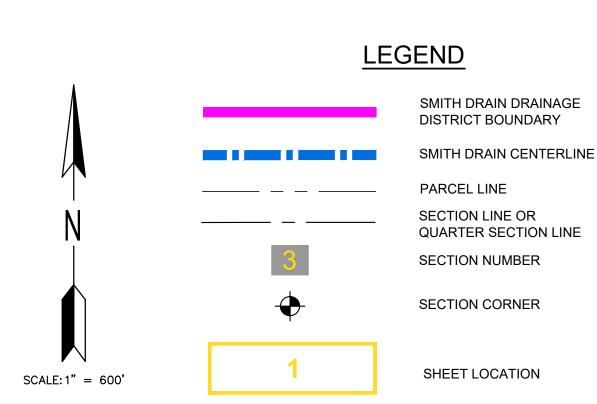

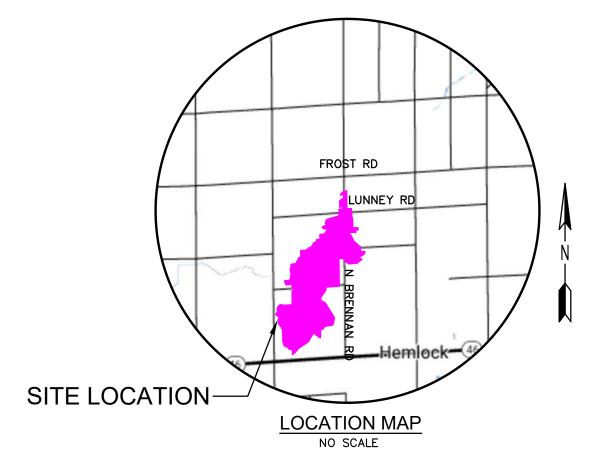

SHEET INDEX

- COVER SHEET
- SMITH DRAIN PLAN & PROFILE STA 1+00 TO STA 21+00
- SMITH DRAIN PLAN & PROFILE STA 21+00 TO STA 41+00
- SMITH DRAIN PLAN & PROFILE STA 41+00 TO STA 61+00
- 5. SMITH DRAIN PLAN & PROFILE STA 61+00 TO STA 81+00
- SMITH DRAIN PLAN & PROFILE STA 81+00 TO STA 101+00
- SMITH DRAIN PLAN & PROFILE STA 101+00 TO STA 119+30
- SOIL EROSION AND SEDIMENTATION CONTROL PLAN
- 9. DETAILS

ENG., INC.

SUITE 105

RYAN C McENHILL, PE

16930 ROBBINS ROAD

GRAND HAVEN, MI 49417

PHONE: 616-743-7070

mcenhillr@engdot.com

LIST OF CONTACTS

THE EXISTING UTILITIES LISTED BELOW AND SHOWN ON THESE PLANS REPRESENT THE BEST INFORMATION AVAILABLE. THIS INFORMATION DOES NOT RELIEVE THE CONTRACTOR OF THE RESPONSIBILITY TO BE SATISFIED AS TO IT'S ACCURACY AND THE LOCATION OF THE EXISTING UTILITIES.

SAGINAW COUNTY PUBLIC WORKS COMMISSIONER - COUNTY DRAINS ATTN: BRIAN WENDLING 111 SOUTH MICHIGAN AVE. SAGINAW, MI 48602 ATTN: (989) 790-5258

CONSUMERS ENERGY ATTN: VIRGIE DOWNS 2400 WEISS ST. SAGINAW, MI 48602 PHONE: (989) 529-2720 virgie.downs@cmsenergy.com

GAS CONSUMERS ENERGY ATTN: BENJAMIN LOUIS PHONE: (989) 791-5918 CELL: (517) 581-1424 **EMAIL:BENJAMIN.LEWIS** @CMSENERGY.COM

SAGINAW COUNTY ROAD COMMISSION ATTN: HALEY CHRISTIANSON 3020 SHERIDAN AVE SAGINAW, MI 48601 PHONE: (989) 752-6140

WINDSTREAM COMMUNICATIONS ATTN: DIRK WELTE 1450 N CENTER POINT RD HIAWATHA, IA 52233 PHONE (800) 695-1901

ATTN: KATHY HENDERSON 309 S. WASHINGTON AVE SAGINAW, MI 48607 PHONE:(989) 771-5412 (248)425-1859

FRONTIER COMMUNICATIONS ATTN: DOUG HOVEY 305 S MAIN ST MT PLEASANT, MI 48858 PHONE: (989) 463-5497

GAS TRANSMISSION CONSUMERS ENERGY 2400 WEISS ST SAGINAW, MI 48602 PHONE (517) 416 3269 DIRK.WELTE@CMSENERGY.COM

RYAN C. MCENHILL, P.E. #56096

9-11-2023

DATE

COVER SHEET

PROJECT NO. 23011

SHEET NO.

OF

- 1. FOR ACCESS CLEARING, ALL TREES REMOVED MUST BE CHIPPED OR HAVE LOGS STACKED WITHIN THE EASEMENT LIMITS. ALL OTHER WOODY MATERIAL MUST BE CHIPPED, OR REMOVED FROM SITE. BURYING ON SITE IS ALLOWED ONLY IN WOODED AREAS. ALL TREES REMOVED FROM DITCH BOTTOM OR SIDES MUST BE CUT FLUSH.
- 2. SPOILS TO BE PLACED AND LEVELED ALONG THE WORKING SIDE OF THE DRAIN, SO AS NOT TO AFFECT THE EXISTING DRAINAGE PATTERNS.
- 3. LEVEL, MULCH, AND SEED SPOILS IN YARD AND WOODED AREAS WITH OPEN CHANNEL SEED MIX. SPOILS ADJACENT TO AGRICULTURAL FIELDS SHALL NOT BE SEEDED. SPOILS SHALL NOT

5+00

CUT (TYP)

- PROPOSED

(5' MIN FOR AREAS

OF TAPERING)

GRADE (TYP)

EX GRADE (TYP) —

HORIZONTAL: 1" = 100'

VERTICAL: 1" = 10'

- BE GREATER THAN 8-INCHES IN HEIGHT IN ANY GIVEN AREA. 4. PROPERTY OWNERS MUST BE NOTIFIED 7 DAYS PRIOR TO ANY ACCESS AND TREE REMOVALS ON THEIR PROPERTY.
- 5. SITE ACCESS IS RESTRICTED TO EXISTING DRAIN EASEMENTS, TEMPORARY ACCESS EASEMENTS, AND PUBLIC RIGHTS OF WAY SHOWN ON DRAWINGS. ALL OTHER ACCESS TO
- SITE SHALL BE APPROVED BY THE OWNER. 6. TEMPORARY SESC MEASURES MUST BE IN PLACE AT 500 FOOT INCREMENTS TO CONTROL SEDIMENT TRANSPORT.
- 7. CLEARING THAT INCLUDES CUTTING AND REMOVAL OF TREES, BRUSH AND SHRUBS UP TO 6 INCHES AS MEASURED AT BREAST HEIGHT (DBH) SHALL BE CONSIDERED AS INCLUDED WITH OTHER RELATED PAY ITEMS.

| SOIL TYPES AND ABBREVIATIONS | | | | | |
|------------------------------|--------|---|--|--|--|
| | 5A | Sumava sandy loam, 0 to 3 percent slopes | | | |
| | 24 | Parkhill-Selfridge complex, 0 to 2 percent slopes | | | |
| | 124A | Selfridge loamy sand, 0 to 3 percent slopes | | | |
| | CvrabA | Conover-Williamstown loams, 0 to 6 percent slopes | | | |

Know what's **below**. Call before you dig.

BM #1 ELEV=645.47 SET SPIKE E. SIDE UTILITY POLE W. SIDE BRENNAN RD N. SIDE OF

BM #2 ELEV=646.01 SET SPIKE SE SIDE UTILITY POLE W. SIDE BRENNAN RD S. SIDE OF

DRIVEWAY #2339

DRIVEWAY #2269

THE LOCATIONS OF EXISTING UNDERGROUND UTILITIES ARE SHOWN IN AN APPROXIMATE WAY ONLY AND HAVE NOT BEEN INDEPENDENTLY VERIFIED BY THE OWNER OR ITS REPRESENTATIVE. THE CONTRACTOR SHALL DETERMINE THE EXACT LOCATION OF ALL EXISTING UTILITIES BEFORE COMMENCING WORK, AND AGREES TO BE FULLY RESPONSIBLE FOR ANY AND ALL DAMAGES WHICH MIGHT BE OCCASIONED BY THE CONTRACTOR'S FAILURE TO EXACTLY LOCATE AND PRESERVE ANY AND ALL UNDERGROUND

LEGEND

= PROPERTY LINE OR R.O.W. LINE ---- = EDGE OF PAVEMENT

_____ X ___ = FENCE

= WETLANDS (AS MARKED BY OTHERS)

= EXISTING CONTOUR ELEVATION = EDGE OF WOODS

> = DECIDUOUS TREE = CONIFEROUS TREE

= BUSH = STUMP — GAS — GAS — = EXISTING GAS LINE

= EXISTING WELL LOCATION

= EXISTING SIGN

= EXISTING MAILBOX = EXISTING LIGHT POLE

= EXISTING GUY ANCHOR

= EXISTING UTILITY POLE = EXISTING TELEPHONE PEDESTAL

= BENCH MARK LOCATION

= EXISTING DRAIN Q

= PROPOSED DRAIN Q

= = SOIL TYPE

= TEMPORARY SOIL EROSION CONTROL MEASURE

= PERMANENT SOIL EROSION CONTROL MEASURE OR RESTORATION DETAIL

= HMA DRIVEWAY/ROADWAY RESTORATION


KEY PLAN NO SCALE

SMITH DRAIN PLAN & PROFILE STA 1+00 TO STA 21+00

SHEET SPECIFIC NOTES:


1. WORK IS TO BE COMPLETED FROM THE EAST SIDE OF DRAIN NORTH OF LUNNEY ROAD AND FROM


THE WEST SIDE OF DRAIN SOUTH OF LUNNEY ROAD FOR THIS SHEET.

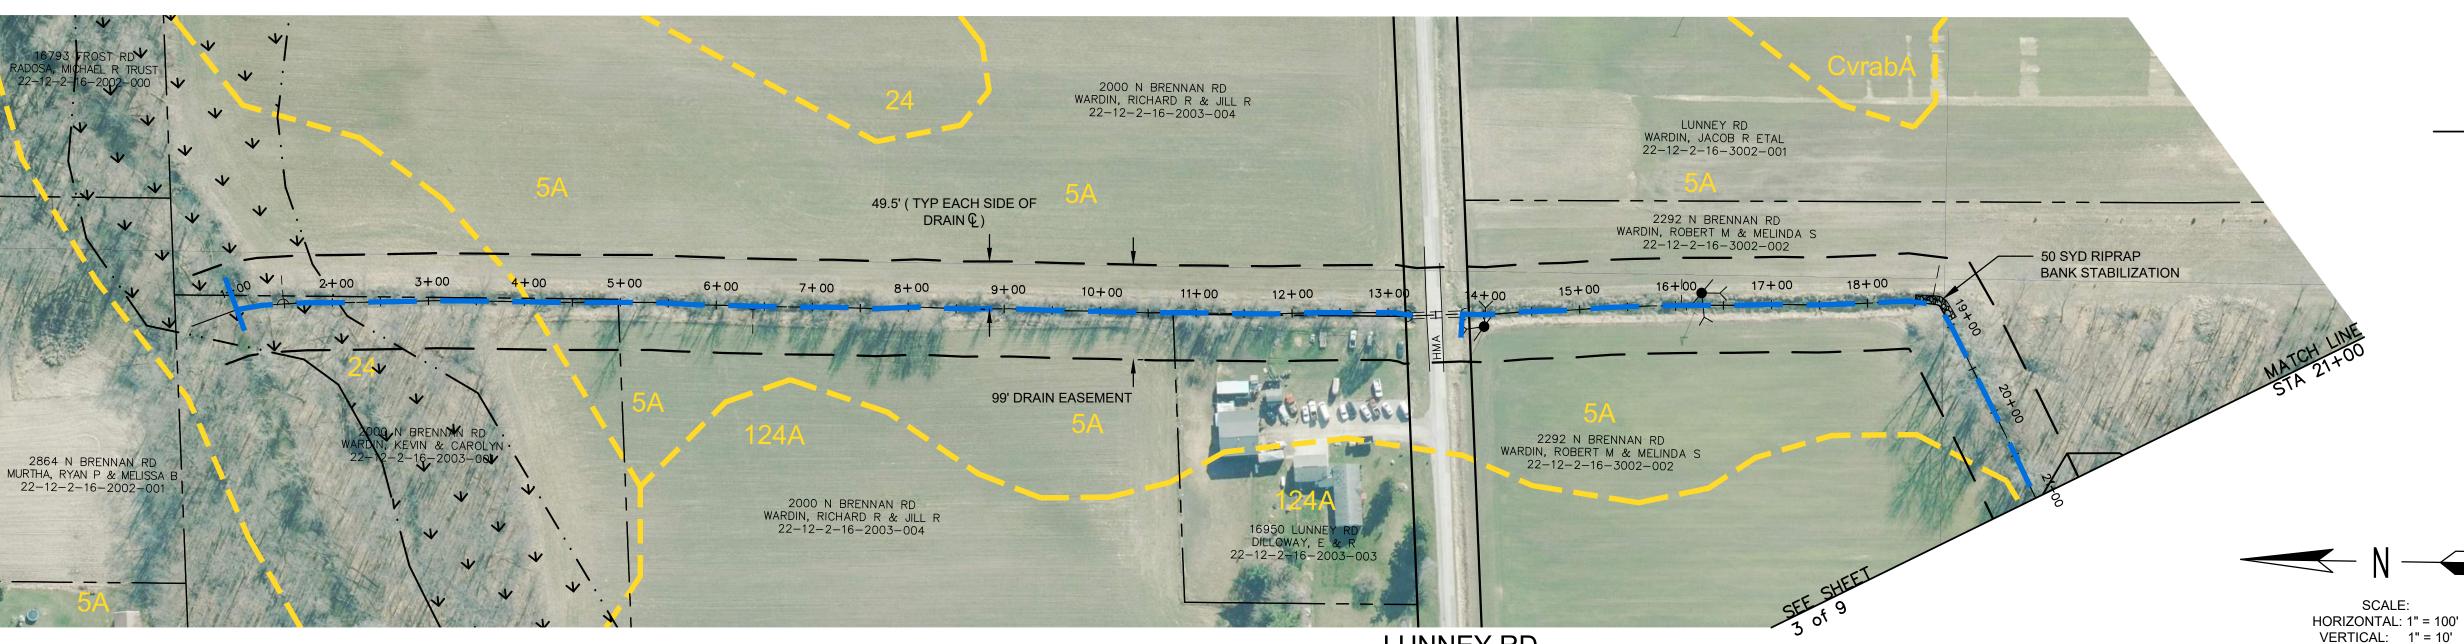

SMITH DRAIN (99' DRAIN EASEMENT)


LUNNEY RD (66' R.O.W.)

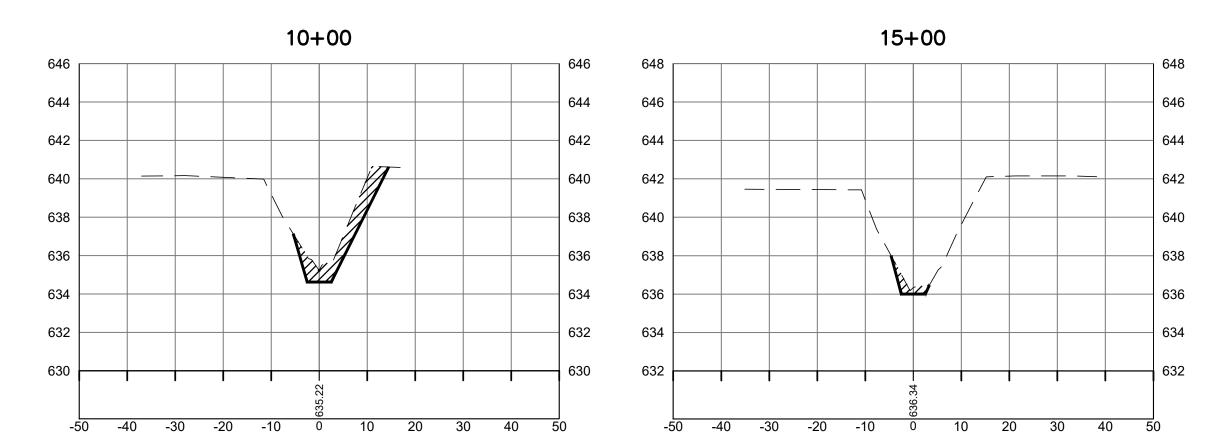

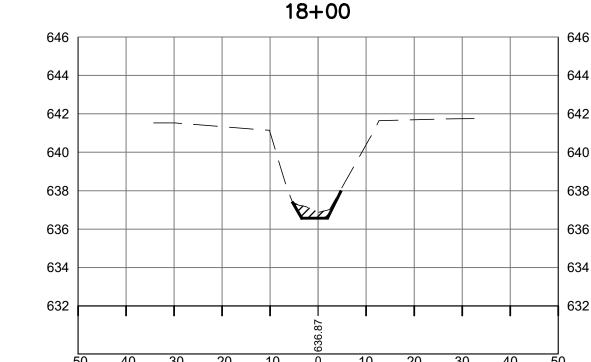

CROSS SECTIONS


SCALE: HORIZONTAL: 1" = 20' VERTICAL: 1" = 5'

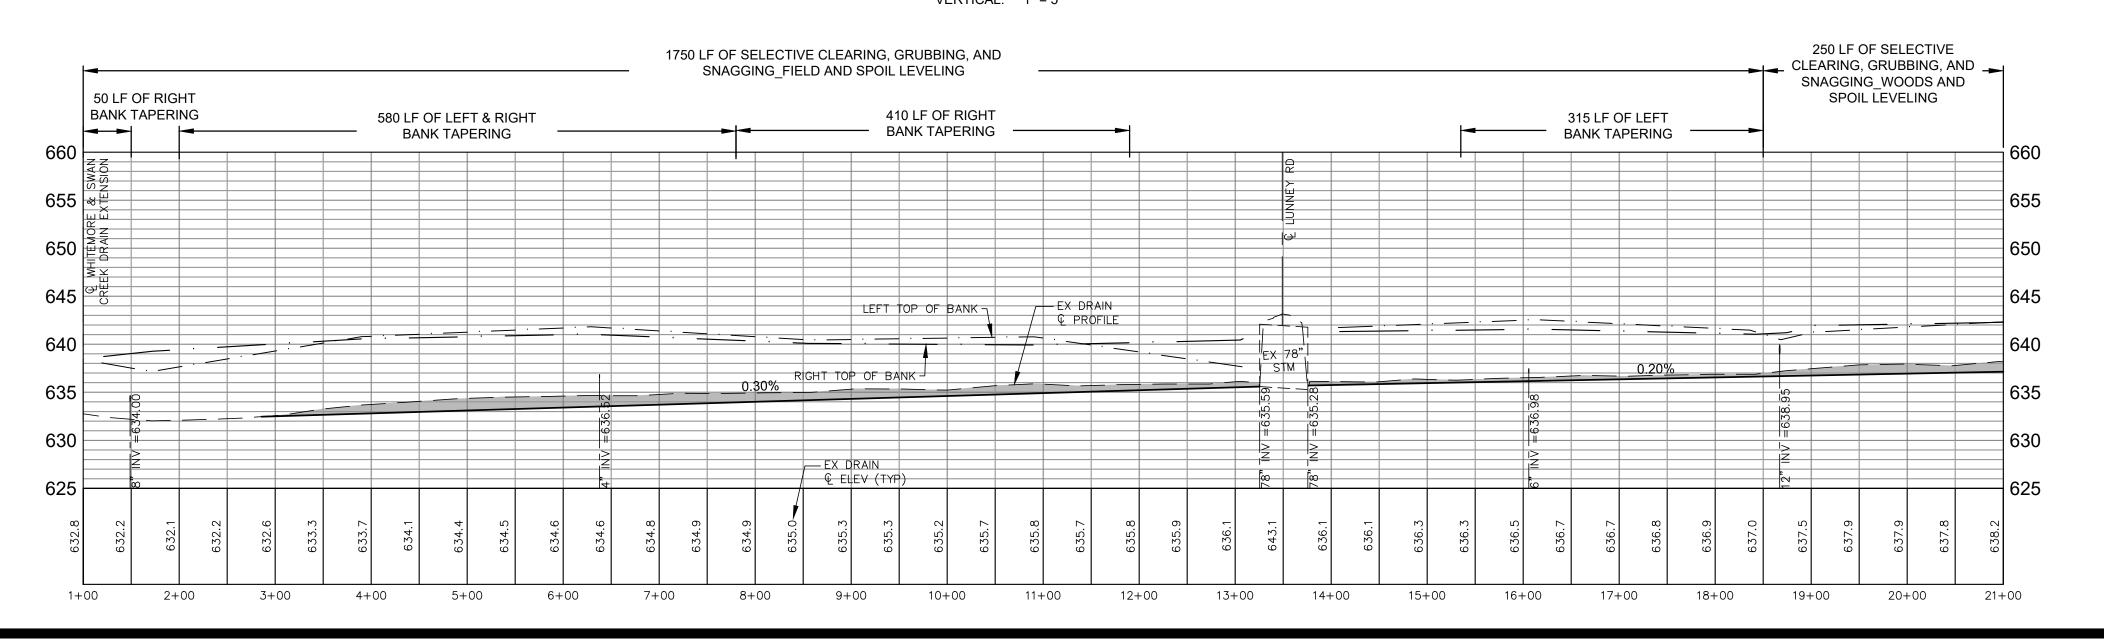

SHEET NO. **2** of

PROJECT NO.

23011

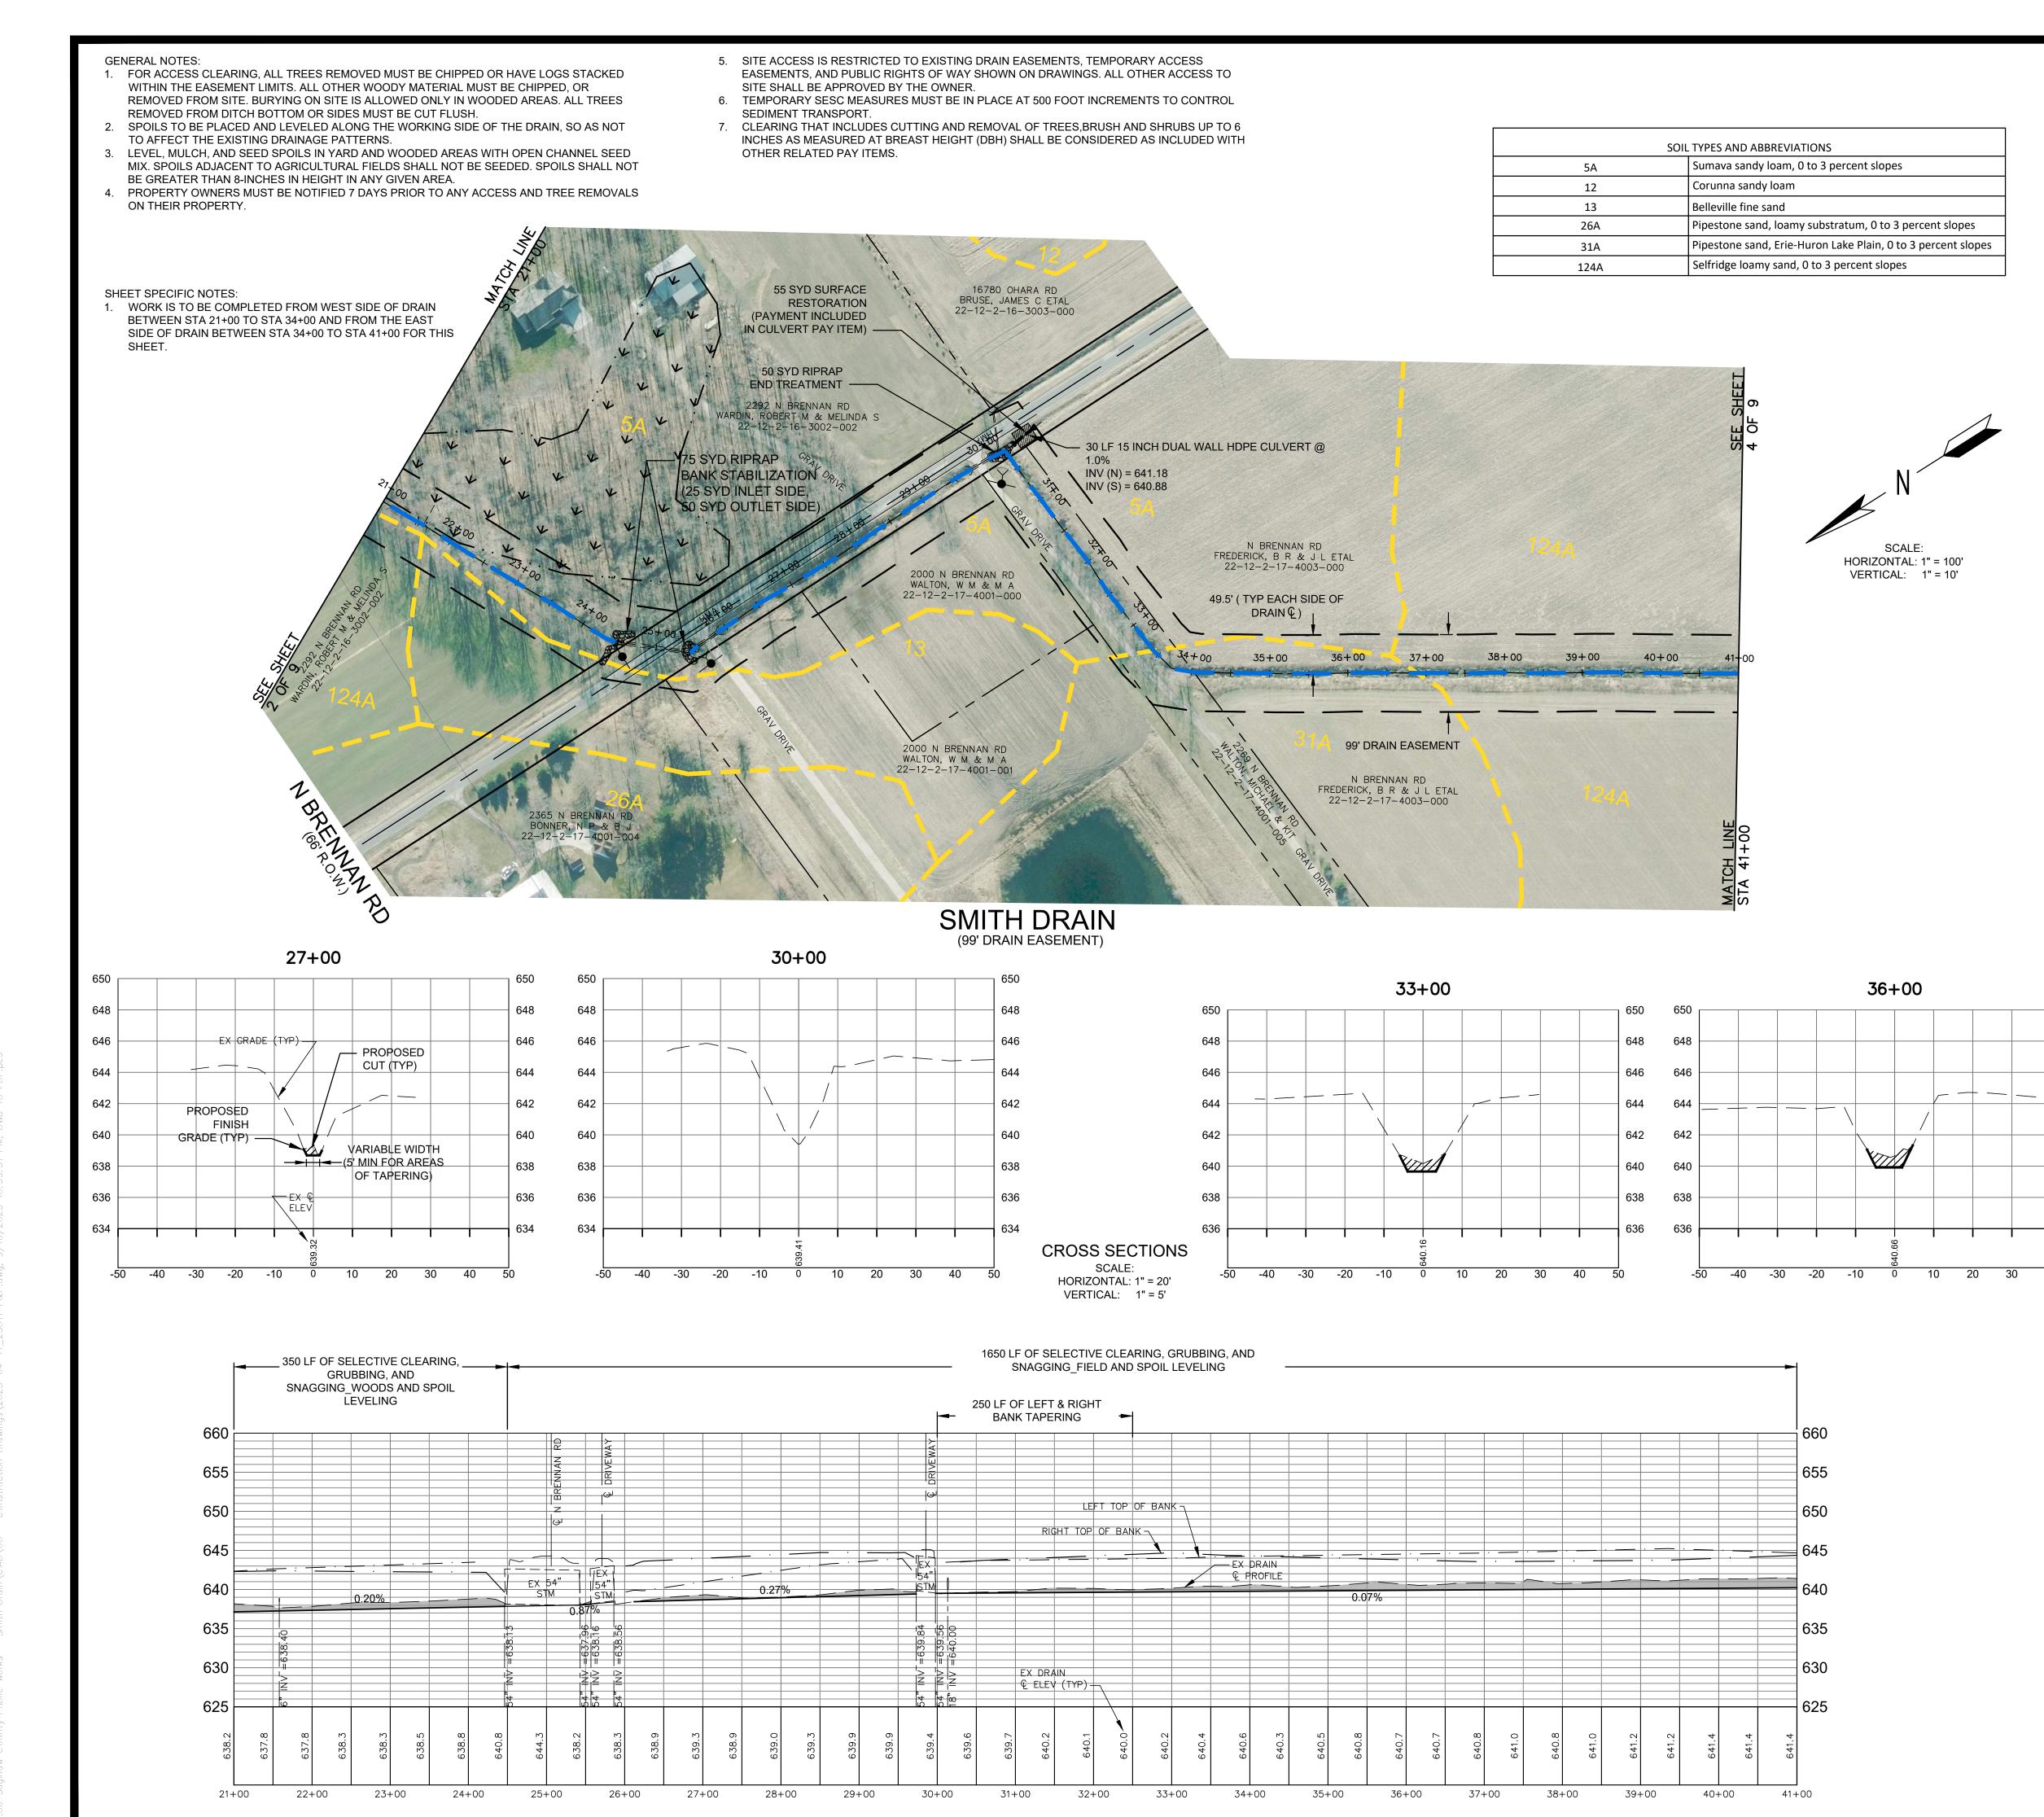

SET "SPIKE E. SIDE UTILITY POLE W. SIDE BRENNAN RD N. SIDE OF DRIVEWAY #2339 ELEV=646.01

SET SPIKE SE SIDE UTILITY POLE W. SIDE BRENNAN RD S. SIDE OF DRIVEWAY #2269



THE LOCATIONS OF EXISTING UNDERGROUND UTILITIES ARE SHOWN IN AN APPROXIMATE WAY ONLY AND HAVE NOT BEEN INDEPENDENTLY VERIFIED BY THE OWNER OR ITS REPRESENTATIVE. THE CONTRACTOR SHALL DETERMINE TH EXACT LOCATION OF ALL EXISTING UTILITIES BEFORE COMMENCING WORK, AND AGREES TO BE FULLY RESPONSIBLE FOR ANY AND ALL DAMAGES WHICH MIGHT BE OCCASIONED BY THE CONTRACTOR'S FAILURE TO EXACTLY LOCATE AND PRESERVE ANY AND ALL UNDERGROUND

LEGEND

= PROPERTY LINE OR R.O.W. LINE = EDGE OF PAVEMENT ____ X ___ = FENCE ——○——○——○——○— = EXISTING GUARDRAIL علاد علاد الله = WETLANDS (AS MARKED BY OTHERS)

> = EXISTING CONTOUR ELEVATION = EDGE OF WOODS = DECIDUOUS TREE

= CONIFEROUS TREE = BUSH = STUMP

— GAS — GAS — EXISTING GAS LINE = EXISTING WELL LOCATION

= BENCH MARK LOCATION

= EXISTING SIGN = EXISTING MAILBOX

= EXISTING LIGHT POLE

= EXISTING GUY ANCHOR = EXISTING UTILITY POLE

= EXISTING TELEPHONE PEDESTAL

---- = EXISTING DRAIN Q = PROPOSED DRAIN Q

= TEMPORARY SOIL EROSION CONTROL MEASURE

= PERMANENT SOIL EROSION CONTROL MEASURE OR RESTORATION DETAIL

HMA DRIVEWAY/ROADWAY RESTORATION

= GRAVEL DRIVEWAY/ROADWAY RESTORATION



KEY PLAN NO SCALE


SMITH DRAIN PLAN & PROFILE STA 21+00 TO STA 41+00

BRIAN WENDLING
COUNTY PUBLIC WORKS COMMISSIONE

PROJECT NO. 23011

SAGINAW

SHEET NO.

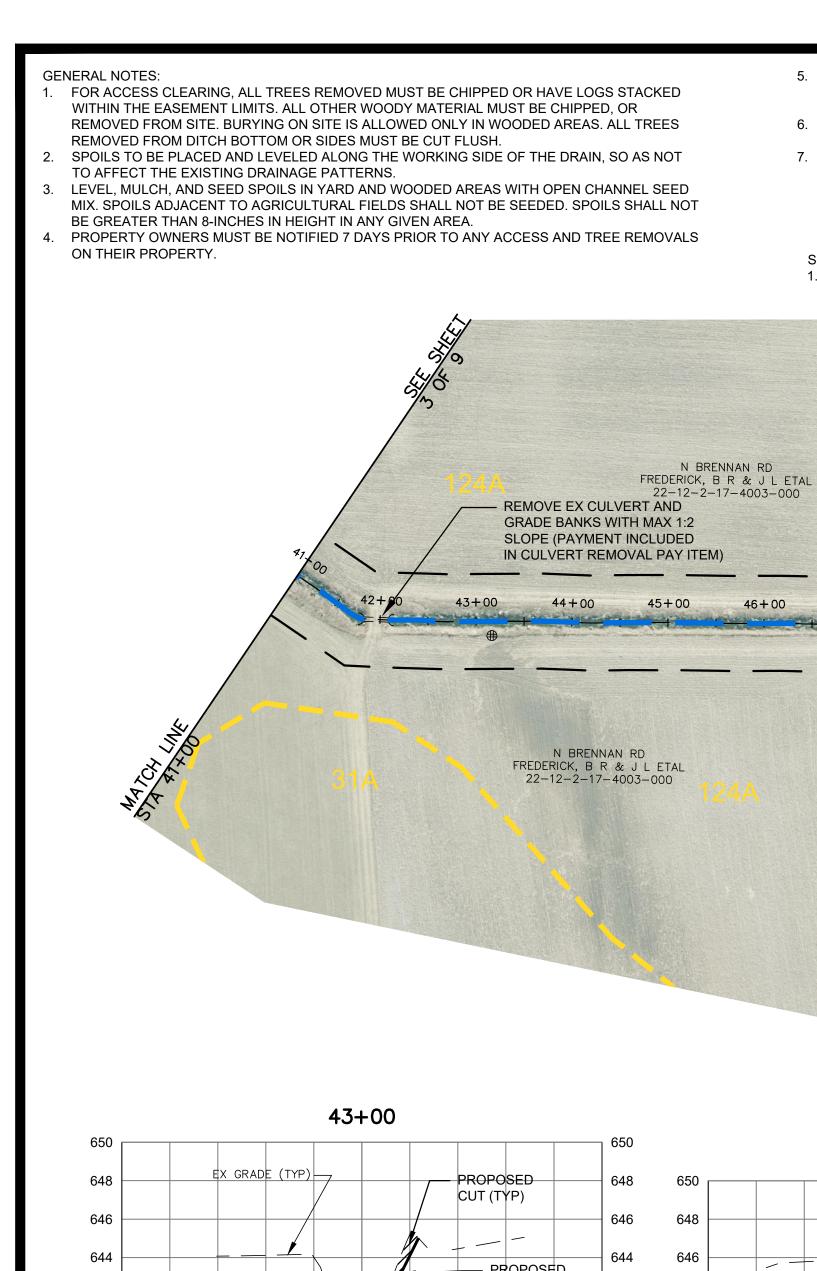

5. SITE ACCESS IS RESTRICTED TO EXISTING DRAIN EASEMENTS, TEMPORARY ACCESS EASEMENTS, AND PUBLIC RIGHTS OF WAY SHOWN ON DRAWINGS. ALL OTHER ACCESS TO SITE SHALL BE APPROVED BY THE OWNER. 6. TEMPORARY SESC MEASURES MUST BE IN PLACE AT 500 FOOT INCREMENTS TO CONTROL

SEDIMENT TRANSPORT. 7. CLEARING THAT INCLUDES CUTTING AND REMOVAL OF TREES, BRUSH AND SHRUBS UP TO 6 INCHES AS MEASURED AT BREAST HEIGHT (DBH) SHALL BE CONSIDERED AS INCLUDED WITH

OTHER RELATED PAY ITEMS.

SHEET SPECIFIC NOTES:

25 SYD RIPRAP

TILE OUTLET


PROTECTION

BANK STABILIZATION —

35 SYD RIPRAP

N BRENNAN RD

SOIL TYPES AND ABBREVIATIONS Parkhill-Selfridge complex, 0 to 2 percent slopes 24 26A Pipestone sand, loamy substratum, 0 to 3 percent slopes 31A Selfridge loamy sand, 0 to 3 percent slopes 124A

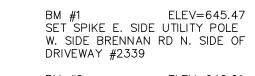


ELEV=646.01 SET SPIKE SE SIDE UTILITY POLE W. SIDE BRENNAN RD S. SIDE OF DRIVEWAY #2269




THE LOCATIONS OF EXISTING UNDERGROUND UTILITIES ARE SHOWN IN AN APPROXIMATE WAY ONLY AND HAVE NOT BEEN INDEPENDENTLY VERIFIED BY THE OWNER OR ITS REPRESENTATIVE. THE CONTRACTOR SHALL DETERMINE TH EXACT LOCATION OF ALL EXISTING UTILITIES BEFORE COMMENCING WORK, AND AGREES TO BE FULLY RESPONSIBLE FOR ANY AND ALL DAMAGES WHICH MIGHT BE OCCASIONED BY THE CONTRACTOR'S FAILURE TO EXACTLY LOCATE AND PRESERVE ANY AND ALL UNDERGROUND

1. WORK IS TO BE COMPLETED FROM THE SOUTH AND EAST SIDES OF DRAIN FOR THIS SHEET. Pipestone sand, Erie-Huron Lake Plain, 0 to 3 percent slopes - 55 SYD SURFACE **RESTORATION OVER** PROPOSED CULVERT LEGEND (PAYMENT INCLUDED IN CULVERT PAY ITEM) = PROPERTY LINE OR R.O.W. LINE = EDGE OF PAVEMENT ___ X ___ = FENCE N BRENNAN RD KACKMEISTER, NOLAN ─────────────────────────────────── = EXISTING GUARDRAIL 22-12-2-20-1001-000 = WETLANDS (AS MARKED BY OTHERS) 49.5' (TYP EACH SIDE OF DRAIN C) = EXISTING CONTOUR ELEVATION = EDGE OF WOODS = DECIDUOUS TREE = CONIFEROUS TREE = BUSH = STUMP HORIZONTAL: 1" = 100' 99' DRAIN EASEMENT — gas — gas — = EXISTING GAS LINE VERTICAL: 1" = 10' = EXISTING WELL LOCATION N BRENNAN R KACKMEISTER, NOLA = BENCH MARK LOCATION 22-12-2-20-1001-= EXISTING SIGN = EXISTING MAILBOX

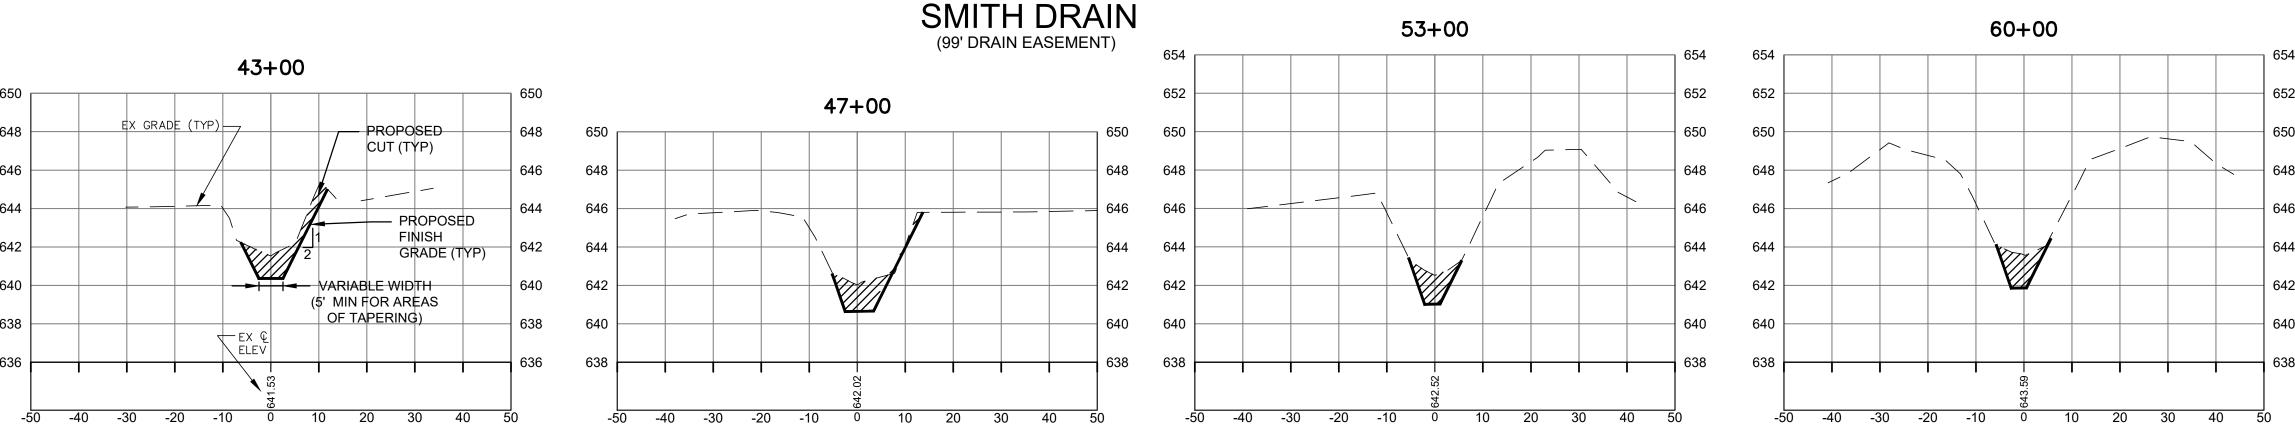

CROSS SECTIONS SCALE: HORIZONTAL: 1" = 20' VERTICAL: 1" = 5'

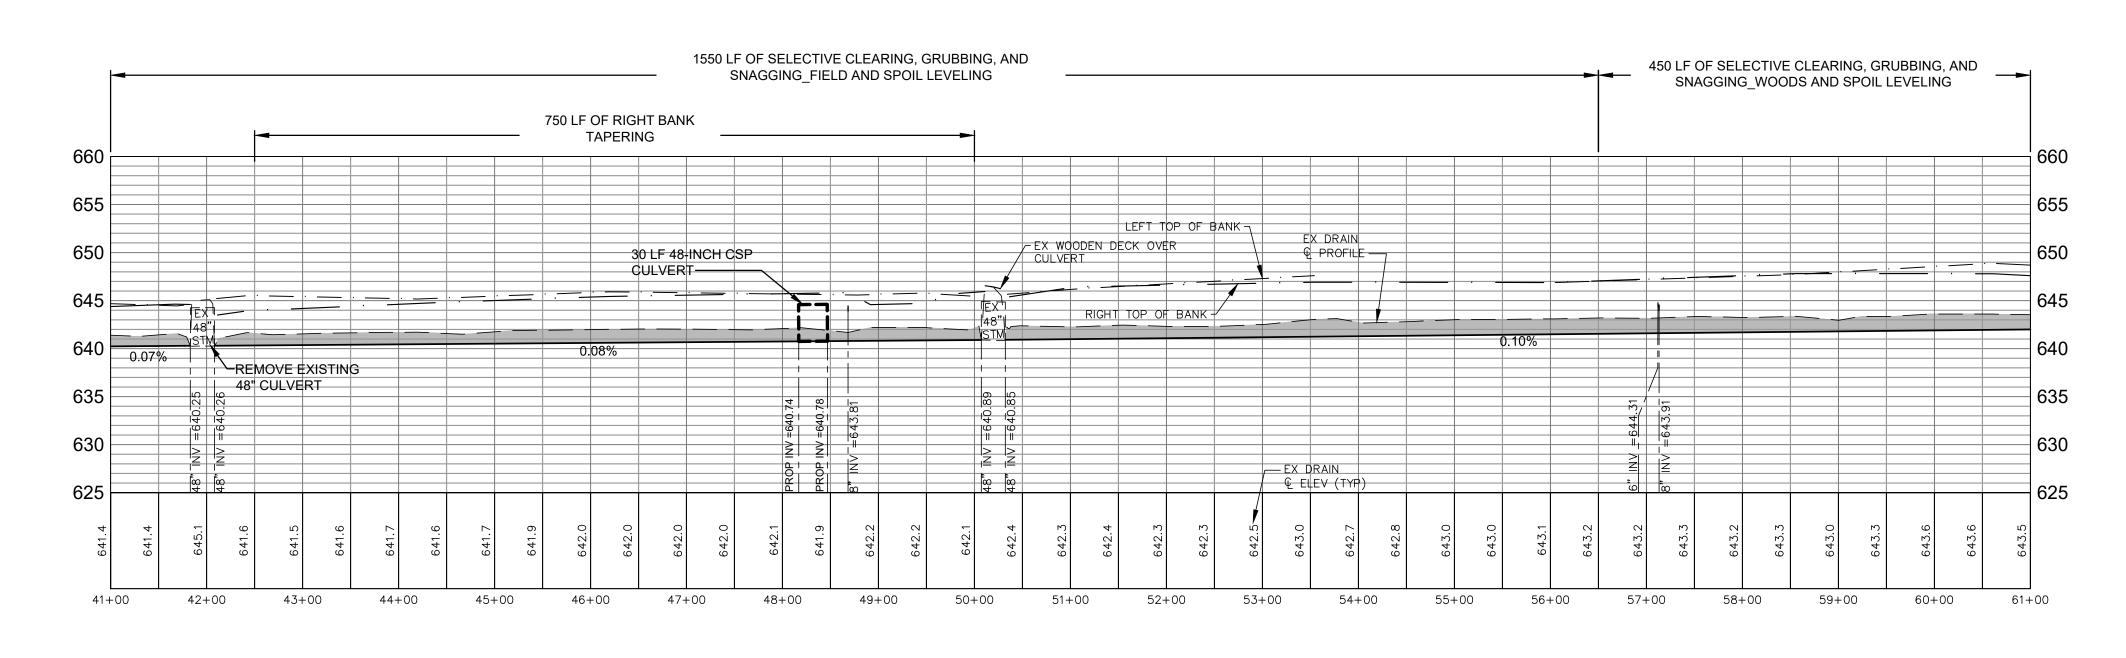



= EXISTING LIGHT POLE

= EXISTING GUY ANCHOR

= EXISTING UTILITY POLE

= EXISTING DRAIN Q

= PROPOSED DRAIN Ç

_a = = = SOIL TYPE

= EXISTING TELEPHONE PEDESTAL

= TEMPORARY SOIL EROSION CONTROL MEASURE

= PERMANENT SOIL EROSION CONTROL MEASURE

HMA DRIVEWAY/ROADWAY RESTORATION

= SURFACE RESTORATION

KEY PLAN NO SCALE

SMITH DRAIN PLAN & PROFILE STA 41+00 TO STA 61+00

PROJECT NO. 23011

SHEET NO.

- 1. FOR ACCESS CLEARING, ALL TREES REMOVED MUST BE CHIPPED OR HAVE LOGS STACKED WITHIN THE EASEMENT LIMITS. ALL OTHER WOODY MATERIAL MUST BE CHIPPED, OR REMOVED FROM SITE. BURYING ON SITE IS ALLOWED ONLY IN WOODED AREAS. ALL TREES REMOVED FROM DITCH BOTTOM OR SIDES MUST BE CUT FLUSH.
- 2. SPOILS TO BE PLACED AND LEVELED ALONG THE WORKING SIDE OF THE DRAIN, SO AS NOT TO AFFECT THE EXISTING DRAINAGE PATTERNS.

66+00

EX GRADE (TYP)

PROPOSED

(5' MIN FOR AREAS OF TAPERING)

PROPOSED

- 3. LEVEL, MULCH, AND SEED SPOILS IN YARD AND WOODED AREAS WITH OPEN CHANNEL SEED MIX. SPOILS ADJACENT TO AGRICULTURAL FIELDS SHALL NOT BE SEEDED. SPOILS SHALL NOT BE GREATER THAN 8-INCHES IN HEIGHT IN ANY GIVEN AREA.
- 4. PROPERTY OWNERS MUST BE NOTIFIED 7 DAYS PRIOR TO ANY ACCESS AND TREE REMOVALS ON THEIR PROPERTY.
- 5. SITE ACCESS IS RESTRICTED TO EXISTING DRAIN EASEMENTS, TEMPORARY ACCESS EASEMENTS, AND PUBLIC RIGHTS OF WAY SHOWN ON DRAWINGS. ALL OTHER ACCESS TO SITE SHALL BE APPROVED BY THE OWNER.
- 6. TEMPORARY SESC MEASURES MUST BE IN PLACE AT 500 FOOT INCREMENTS TO CONTROL
- SEDIMENT TRANSPORT. 7. CLEARING THAT INCLUDES CUTTING AND REMOVAL OF TREES, BRUSH AND SHRUBS UP TO 6 INCHES AS MEASURED AT BREAST HEIGHT (DBH) SHALL BE CONSIDERED AS INCLUDED WITH OTHER RELATED PAY ITEMS.

| | SOIL | SOIL TYPES AND ABBREVIATIONS | | | |
|---|------|---|--|--|--|
| | 5A | Sumava sandy loam, 0 to 3 percent slopes | | | |
| | 13 | Belleville fine sand | | | |
| | 24 | Parkhill-Selfridge complex, 0 to 2 percent slopes | | | |
| | 33 | Granby fine sand | | | |
| Ī | 124A | Selfridge loamy sand, 0 to 3 percent slopes | | | |

BM #1 ELEV=645.47 SET SPIKE E. SIDE UTILITY POLE W. SIDE BRENNAN RD N. SIDE OF DRIVEWAY #2339 ELEV=646.01 SET SPIKE SE SIDE UTILITY POLE

W. SIDE BRENNAN RD S. SIDE OF DRIVEWAY #2269



THE LOCATIONS OF EXISTING UNDERGROUND UTILITIES ARE SHOWN IN AN APPROXIMATE WAY ONLY AND HAVE NOT BEEN INDEPENDENTLY VERIFIED BY THE OWNER OR ITS REPRESENTATIVE. THE CONTRACTOR SHALL DETERMINE THI EXACT LOCATION OF ALL EXISTING UTILITIES BEFORE COMMENCING WORK, AND AGREES TO BE FULLY RESPONSIBLE FOR ANY AND ALL DAMAGES WHICH MIGHT BE OCCASIONED BY THE CONTRACTOR'S FAILURE TO EXACTLY LOCATE AND PRESERVE ANY AND ALL UNDERGROUND



- = PROPERTY LINE OR R.O.W. LINE
- ---- = EDGE OF PAVEMENT

_____ X ___ = FENCE

= WETLANDS (AS MARKED BY OTHERS)

= EXISTING CONTOUR ELEVATION = EDGE OF WOODS = DECIDUOUS TREE

> = CONIFEROUS TREE = BUSH

= STUMP — GAS — GAS — EXISTING GAS LINE = EXISTING WELL LOCATION

= BENCH MARK LOCATION

= EXISTING SIGN = EXISTING MAILBOX

= EXISTING LIGHT POLE = EXISTING GUY ANCHOR

= EXISTING UTILITY POLE

= EXISTING TELEPHONE PEDESTAL

= EXISTING DRAIN φ = PROPOSED DRAIN Q

___ = = SOIL TYPE

SCALE:


= TEMPORARY SOIL EROSION CONTROL MEASURE


= PERMANENT SOIL EROSION CONTROL MEASURE OR RESTORATION DETAIL

= HMA DRIVEWAY/ROADWAY RESTORATION

KEY PLAN NO SCALE


SMITH DRAIN PLAN & PROFILE STA 61+00 TO STA 81+00

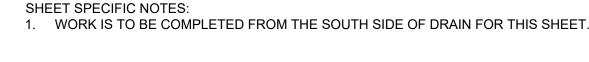

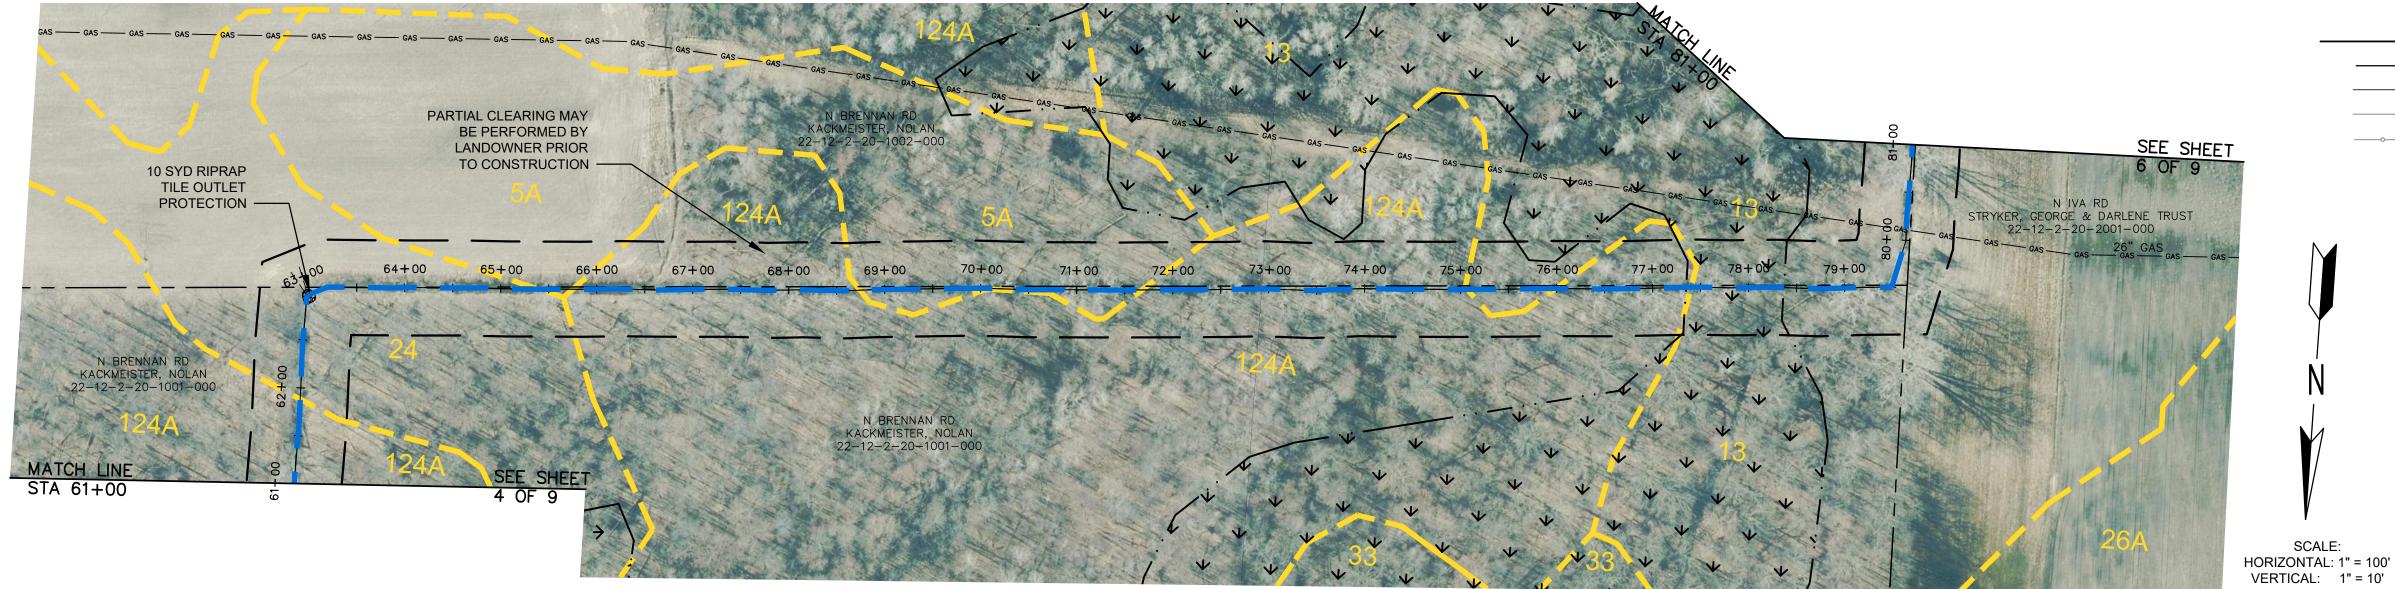






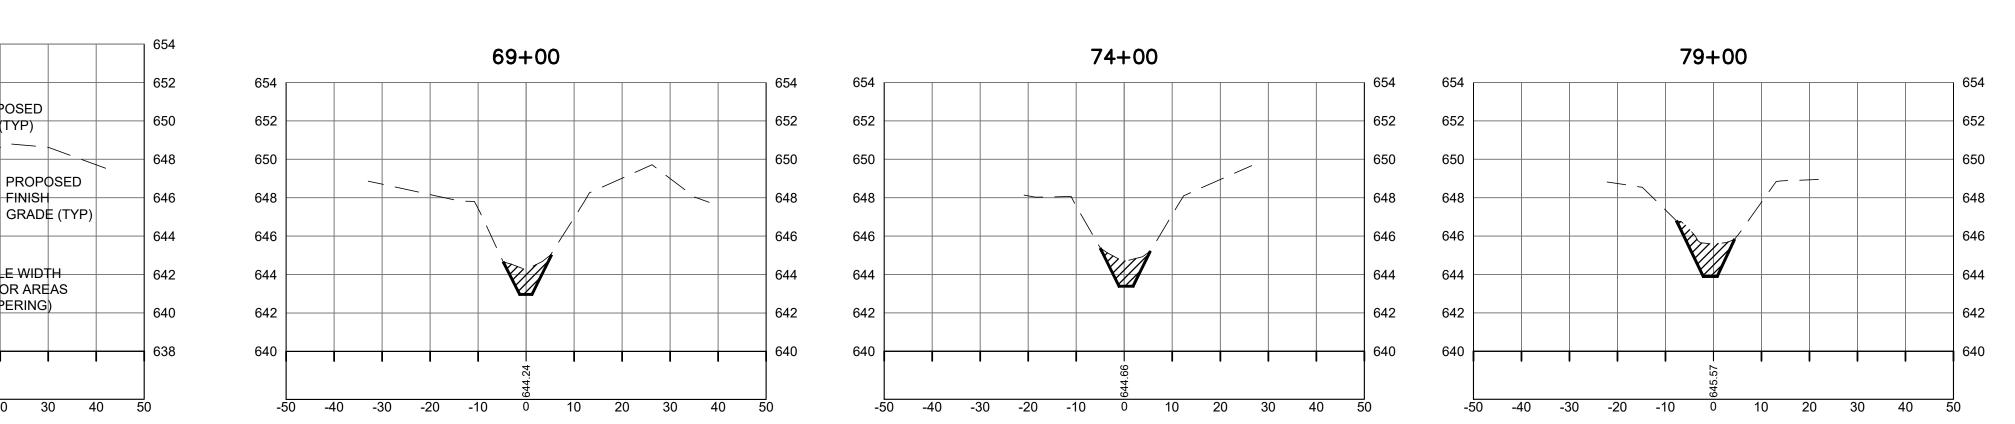

CROSS SECTIONS SCALE: HORIZONTAL: 1" = 20' VERTICAL: 1" = 5'

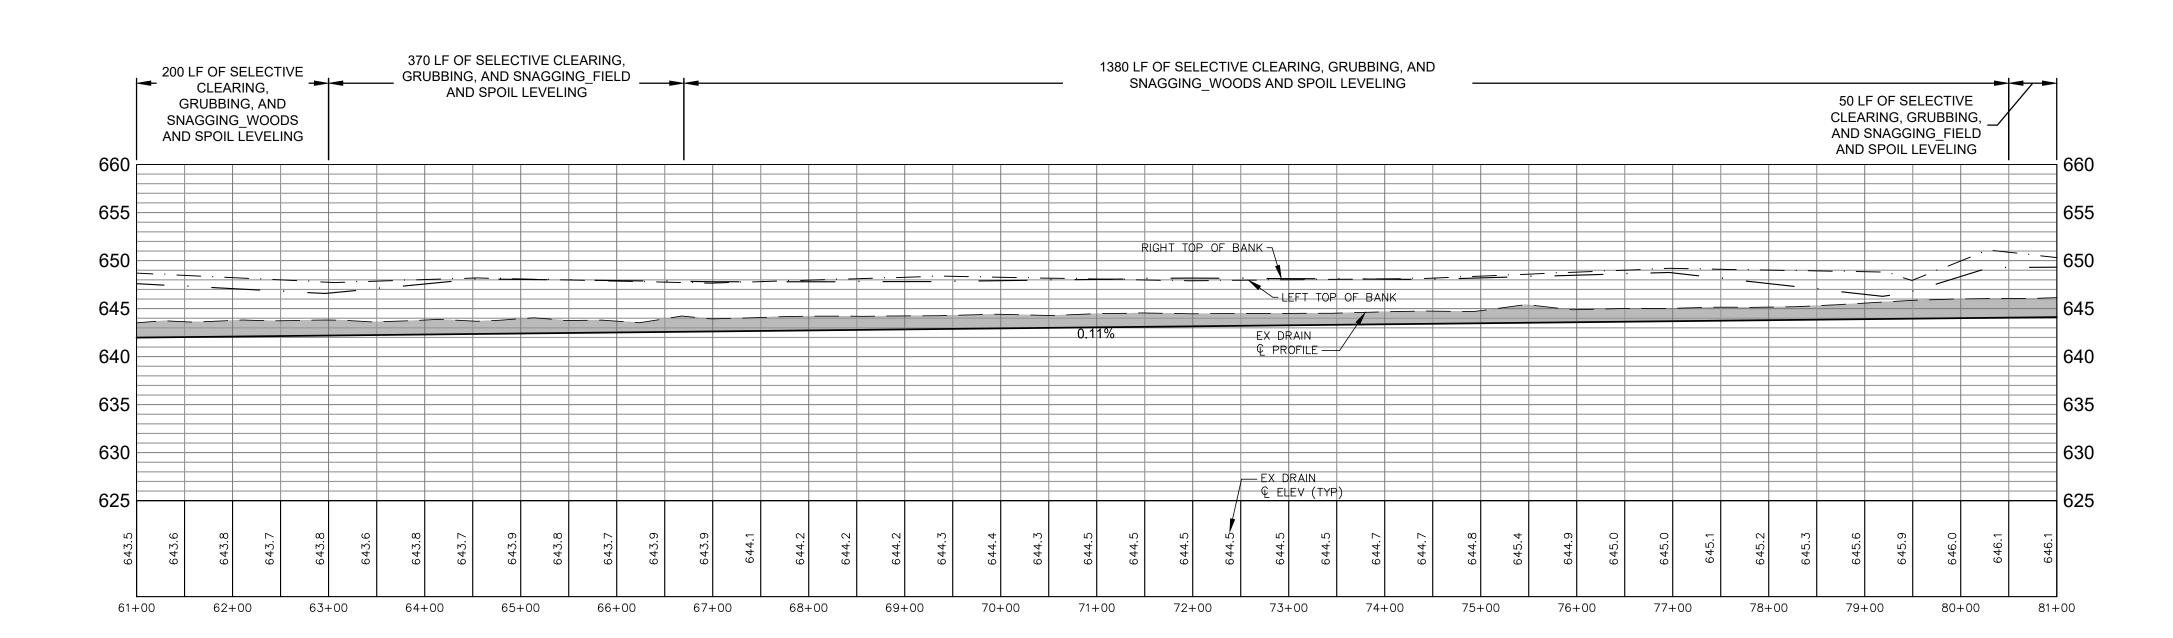

PROJECT NO.

23011

5 of 9

SHEET NO.

1. FOR ACCESS CLEARING, ALL TREES REMOVED MUST BE CHIPPED OR HAVE LOGS STACKED WITHIN THE EASEMENT LIMITS. ALL OTHER WOODY MATERIAL MUST BE CHIPPED, OR REMOVED FROM SITE. BURYING ON SITE IS ALLOWED ONLY IN WOODED AREAS. ALL TREES REMOVED FROM DITCH BOTTOM OR SIDES MUST BE CUT FLUSH.

- 2. SPOILS TO BE PLACED AND LEVELED ALONG THE WORKING SIDE OF THE DRAIN, SO AS NOT TO AFFECT THE EXISTING DRAINAGE PATTERNS.
- 3. LEVEL, MULCH, AND SEED SPOILS IN YARD AND WOODED AREAS WITH OPEN CHANNEL SEED MIX. SPOILS ADJACENT TO AGRICULTURAL FIELDS SHALL NOT BE SEEDED. SPOILS SHALL NOT BE GREATER THAN 8-INCHES IN HEIGHT IN ANY GIVEN AREA.
- 4. PROPERTY OWNERS MUST BE NOTIFIED 7 DAYS PRIOR TO ANY ACCESS AND TREE REMOVALS ON THEIR PROPERTY.

N IVA RD STRYKER, GEORGE & DARLENE TRUST


82+00


EX GRADE (TYP) -

- 5. SITE ACCESS IS RESTRICTED TO EXISTING DRAIN EASEMENTS, TEMPORARY ACCESS EASEMENTS, AND PUBLIC RIGHTS OF WAY SHOWN ON DRAWINGS. ALL OTHER ACCESS TO SITE SHALL BE APPROVED BY THE OWNER.
- 6. TEMPORARY SESC MEASURES MUST BE IN PLACE AT 500 FOOT INCREMENTS TO CONTROL
- SEDIMENT TRANSPORT. 7. CLEARING THAT INCLUDES CUTTING AND REMOVAL OF TREES, BRUSH AND SHRUBS UP TO 6 INCHES AS MEASURED AT BREAST HEIGHT (DBH) SHALL BE CONSIDERED AS INCLUDED WITH OTHER RELATED PAY ITEMS.

| SOIL TYPES AND ABBREVIATIONS | | | | |
|------------------------------|---|--|--|--|
| 12 | Corunna sandy loam | | | |
| 13 | Belleville fine sand | | | |
| 26A | Pipestone sand, loamy substratum, 0 to 3 percent slopes | | | |
| 124A | Selfridge loamy sand, 0 to 3 percent slopes | | | |
| | | | | |

SHEET SPECIFIC NOTES: 1. WORK IS TO BE COMPLETED FROM THE WEST SIDE OF DRAIN FOR THIS SHEET.

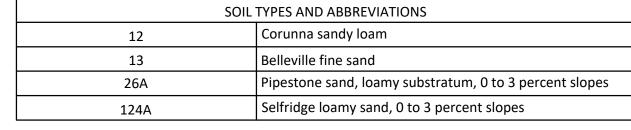

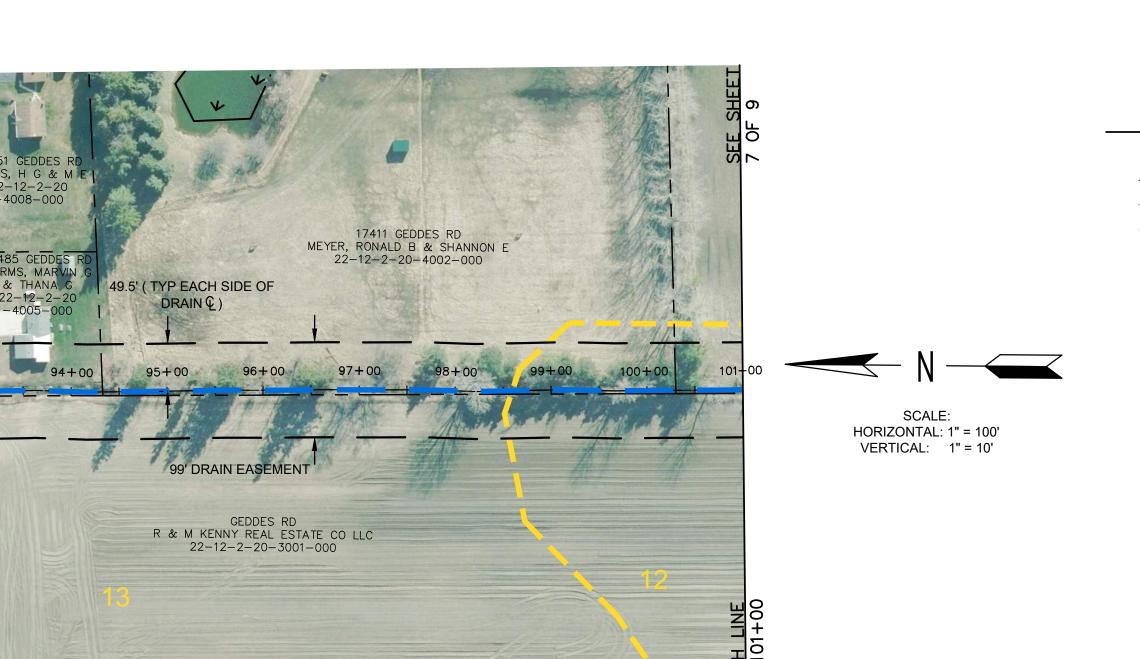


SMITH DRAIN (99' DRAIN EASEMENT)

GEDDES RD 35 SYD DOWNSTREAM) — KEHOE, JAMES R & MARGARET E TR

22-12-2-20-2005-000


GEDDES RD (66' R.O.W.)

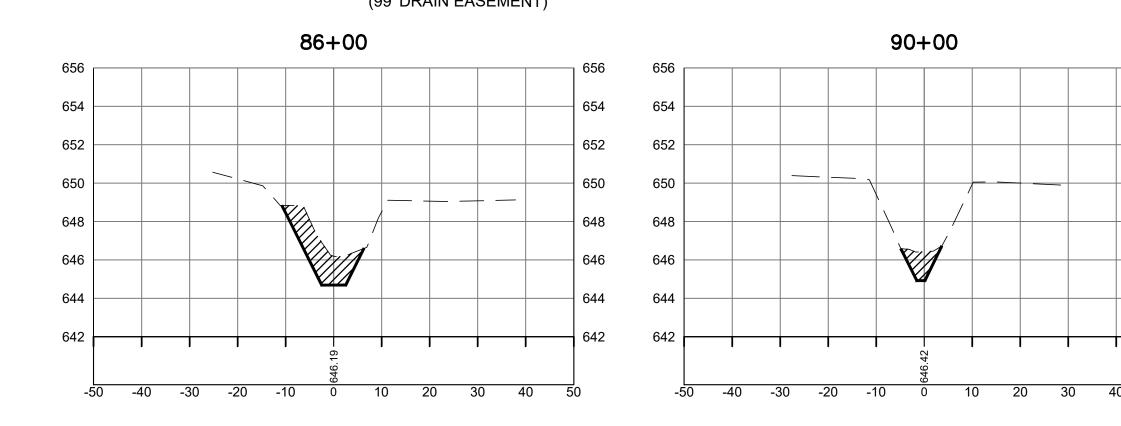

80 SYD RIPRAP


END TREATMENT

(45 SYD UPSTREAM,

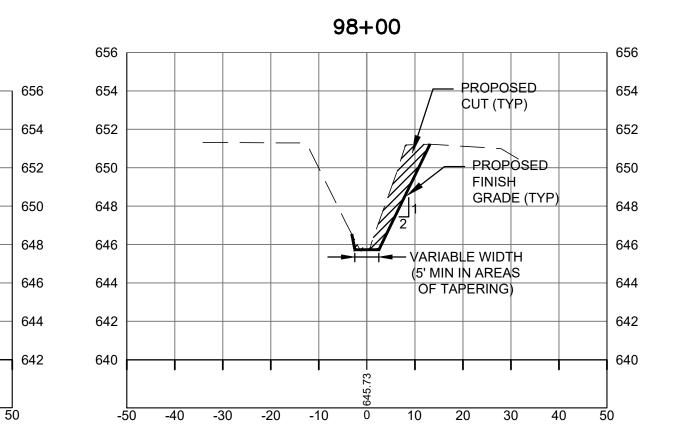

CROSS SECTIONS

SCALE:
HORIZONTAL: 1" = 20' VERTICAL: 1" = 5'

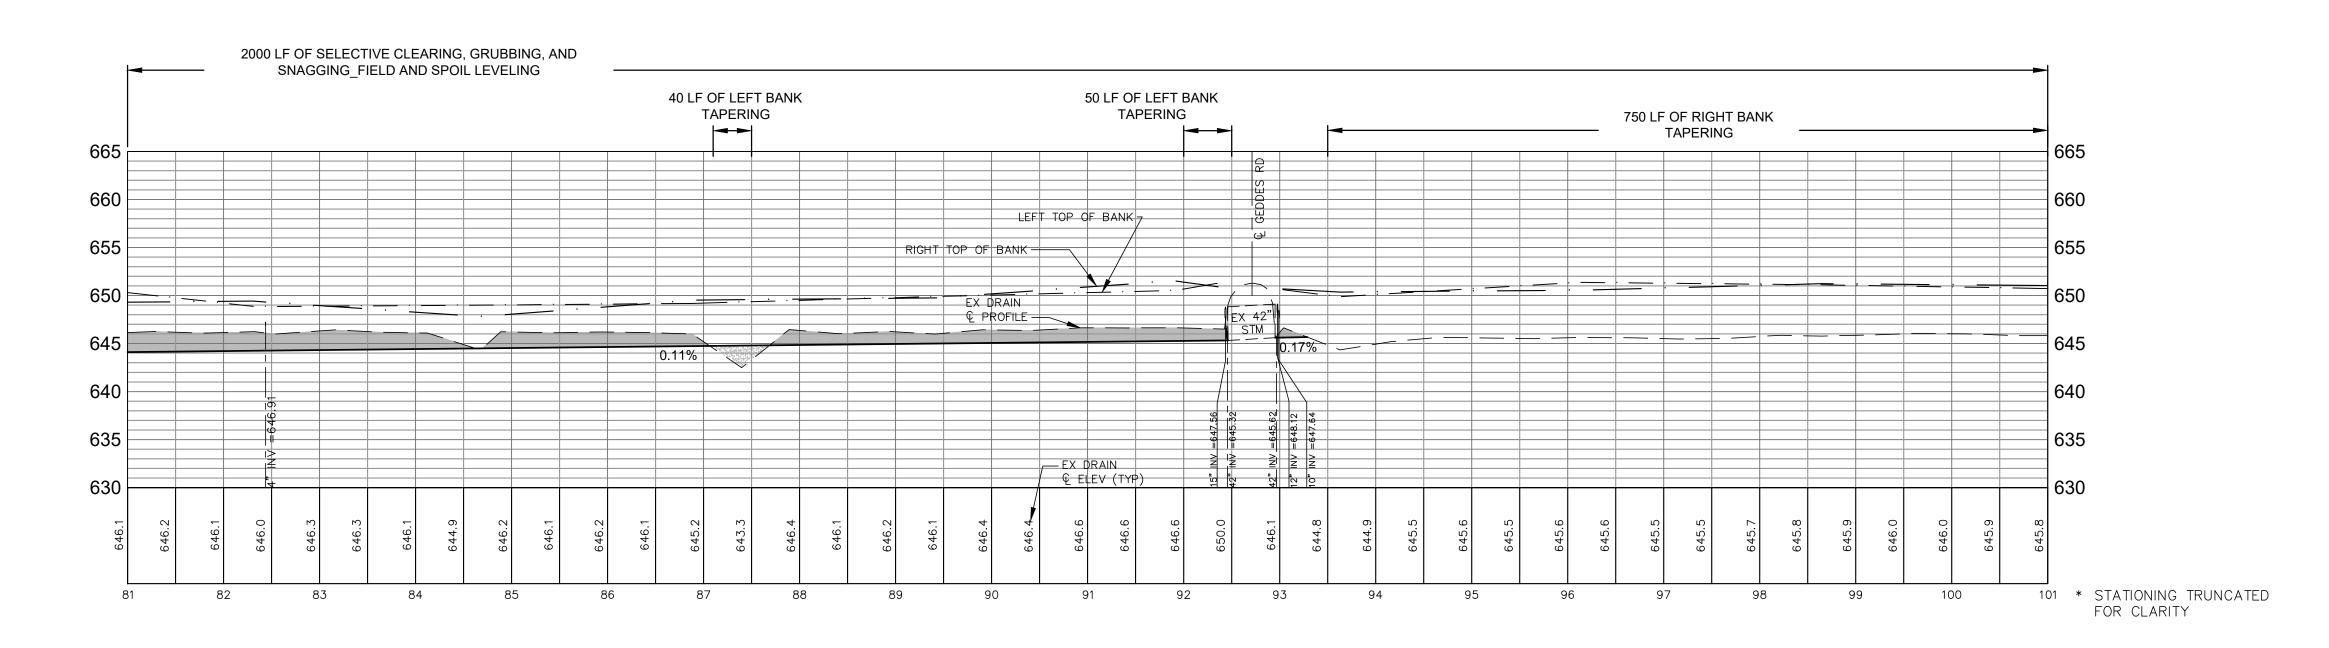

BM #1 ELEV=645.47 SET SPIKE E. SIDE UTILITY POLE W. SIDE BRENNAN RD N. SIDE OF DRIVEWAY #2339 ELEV=646.01

SET SPIKE SE SIDE UTILITY POLE
W. SIDE BRENNAN RD S. SIDE OF DRIVEWAY #2269



THE LOCATIONS OF EXISTING UNDERGROUND UTILITIES ARE SHOWN IN AN APPROXIMATE WAY ONLY AND HAVE NOT BEEN INDEPENDENTLY VERIFIED BY THE OWNER OR ITS REPRESENTATIVE. THE CONTRACTOR SHALL DETERMINE THE EXACT LOCATION OF ALL EXISTING UTILITIES BEFORE COMMENCING WORK, AND AGREES TO BE FULLY RESPONSIBLE FOR ANY AND ALL DAMAGES WHICH MIGHT BE OCCASIONED BY THE CONTRACTOR'S FAILURE TO EXACTLY LOCATE AND PRESERVE ANY AND ALL UNDERGROUND

LEGEND

= PROPERTY LINE OR R.O.W. LINE - = EDGE OF PAVEMENT _____ X ___ = FENCE

= WETLANDS (AS MARKED BY OTHERS)

= EXISTING CONTOUR ELEVATION = EDGE OF WOODS = DECIDUOUS TREE = CONIFEROUS TREE

= STUMP — gas — gas — = EXISTING GAS LINE

= BUSH

= EXISTING WELL LOCATION

= EXISTING SIGN

= BENCH MARK LOCATION

= EXISTING MAILBOX = EXISTING LIGHT POLE

= EXISTING GUY ANCHOR = EXISTING UTILITY POLE

= EXISTING TELEPHONE PEDESTAL

= PROPOSED DRAIN Q

= = SOIL TYPE

= TEMPORARY SOIL EROSION CONTROL MEASURE

= PERMANENT SOIL EROSION CONTROL MEASURE (P) OR RESTORATION DETAIL

= RIPRAP

= HMA DRIVEWAY/ROADWAY RESTORATION



KEY PLAN NO SCALE

SMITH DRAIN PLAN & PROFILE STA 81+00 TO STA 101+00

BRIAN WENDLING
COUNTY PUBLIC WORKS COMMISSIONER

PROJECT NO. 23011

SHEET NO.

- 1. FOR ACCESS CLEARING, ALL TREES REMOVED MUST BE CHIPPED OR HAVE LOGS STACKED WITHIN THE EASEMENT LIMITS. ALL OTHER WOODY MATERIAL MUST BE CHIPPED, OR REMOVED FROM SITE. BURYING ON SITE IS ALLOWED ONLY IN WOODED AREAS. ALL TREES
- REMOVED FROM DITCH BOTTOM OR SIDES MUST BE CUT FLUSH. 2. SPOILS TO BE PLACED AND LEVELED ALONG THE WORKING SIDE OF THE DRAIN, SO AS NOT
- TO AFFECT THE EXISTING DRAINAGE PATTERNS. 3. LEVEL, MULCH, AND SEED SPOILS IN YARD AND WOODED AREAS WITH OPEN CHANNEL SEED MIX. SPOILS ADJACENT TO AGRICULTURAL FIELDS SHALL NOT BE SEEDED. SPOILS SHALL NOT
- BE GREATER THAN 8-INCHES IN HEIGHT IN ANY GIVEN AREA. 4. PROPERTY OWNERS MUST BE NOTIFIED 7 DAYS PRIOR TO ANY ACCESS AND TREE REMOVALS ON THEIR PROPERTY.

102+00

GEDDES RD

PRIEST, LEANE

22-12-2-20-4002-004

GEDDES RD
R & M KENNY REAL ESTATE CO LLC

22-12-2-20-3001-000

- 5. SITE ACCESS IS RESTRICTED TO EXISTING DRAIN EASEMENTS, TEMPORARY ACCESS EASEMENTS, AND PUBLIC RIGHTS OF WAY SHOWN ON DRAWINGS. ALL OTHER ACCESS TO SITE SHALL BE APPROVED BY THE OWNER.
- 6. TEMPORARY SESC MEASURES MUST BE IN PLACE AT 500 FOOT INCREMENTS TO CONTROL
- SEDIMENT TRANSPORT. 7. CLEARING THAT INCLUDES CUTTING AND REMOVAL OF TREES, BRUSH AND SHRUBS UP TO 6 INCHES AS MEASURED AT BREAST HEIGHT (DBH) SHALL BE CONSIDERED AS INCLUDED WITH OTHER RELATED PAY ITEMS.

1. WORK IS TO BE COMPLETED FROM THE WEST SIDE OF DRAIN FOR THIS SHEET.

N BRENNAN RD

KENNY, PATRICK B & LISA S

22-12-2-20-4003-000

110+00

99' DRAIN EASEMENT

N IVA RD R & M KENNY REAL ESTATE CO LLC

22-12-2-20-3009-000

108+00

49.5' (TYP EACH SIDE OF

DRAIN (L)

109+00

108+00

SHEET SPECIFIC NOTES:

107+00

105+00

| SOIL TYPES AND ABBREVIATIONS | | | | |
|------------------------------|---|--|--|--|
| 12 | Corunna sandy loam | | | |
| 13 | Belleville fine sand | | | |
| 24 | Parkhill-Selfridge complex, 0 to 2 percent slopes | | | |
| 45A | Fabius sandy loam, 0 to 3 percent slopes | | | |
| 124A | Selfridge loamy sand, 0 to 3 percent slopes | | | |
| | | | | |

112+00

BM #1 ELEV=645.47 SET SPIKE E. SIDE UTILITY POLE W. SIDE BRENNAN RD N. SIDE OF DRIVEWAY #2339 ELEV=646.01 SET SPIKE SE SIDE UTILITY POLE W. SIDE BRENNAN RD S. SIDE OF DRIVEWAY #2269



THE LOCATIONS OF EXISTING UNDERGROUND UTILITIES ARE SHOWN IN AN APPROXIMATE WAY ONLY AND HAVE NOT BEEN INDEPENDENTLY VERIFIED BY THE OWNER OR ITS REPRESENTATIVE. THE CONTRACTOR SHALL DETERMINE THE EXACT LOCATION OF ALL EXISTING UTILITIES BEFORE COMMENCING WORK, AND AGREES TO BE FULLY RESPONSIBLE FOR ANY AND ALL DAMAGES WHICH MIGHT BE OCCASIONED BY THE CONTRACTOR'S FAILURE TO EXACTLY LOCATE AND PRESERVE ANY AND ALL UNDERGROUND

LEGEND

= PROPERTY LINE OR R.O.W. LINE --- = EDGE OF PAVEMENT


— → → → = EXISTING GUARDRAIL

_____ X ___ = FENCE


UTILITIES.

= WETLANDS (AS MARKED BY OTHERS)

= EXISTING CONTOUR ELEVATION

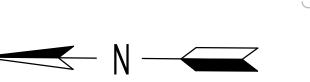

SCALE: HORIZONTAL: 1" = 100' VERTICAL: 1" = 10'

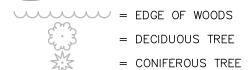

= STUMP

= BUSH

— GAS — GAS — EXISTING GAS LINE = EXISTING WELL LOCATION

= BENCH MARK LOCATION

= TEMPORARY SOIL EROSION CONTROL MEASURE

OR RESTORATION DETAIL

= EXISTING SIGN = EXISTING MAILBOX = EXISTING LIGHT POLE = EXISTING GUY ANCHOR = EXISTING UTILITY POLE = EXISTING TELEPHONE PEDESTAL = PROPOSED DRAIN Ç = = SOIL TYPE

= PERMANENT SOIL EROSION CONTROL MEASURE = RIPRAP

= HMA DRIVEWAY/ROADWAY RESTORATION

KEY PLAN NO SCALE


SMITH DRAIN PLAN & PROFILE STA 101+00 TO STA 119+50

654 654 654 656 - PROPOSED CUT (TYP) PROPOSED GRADE (TYP) (5' MIN FOR AREAS OF TAPERING) **CROSS SECTIONS**

SMITH DRAIN


(99' DRAIN EASEMENT)

SCALE: HORIZONTAL: 1" = 20' VERTICAL: 1" = 5' SNAGGING_FIELD AND SPOIL LEVELING

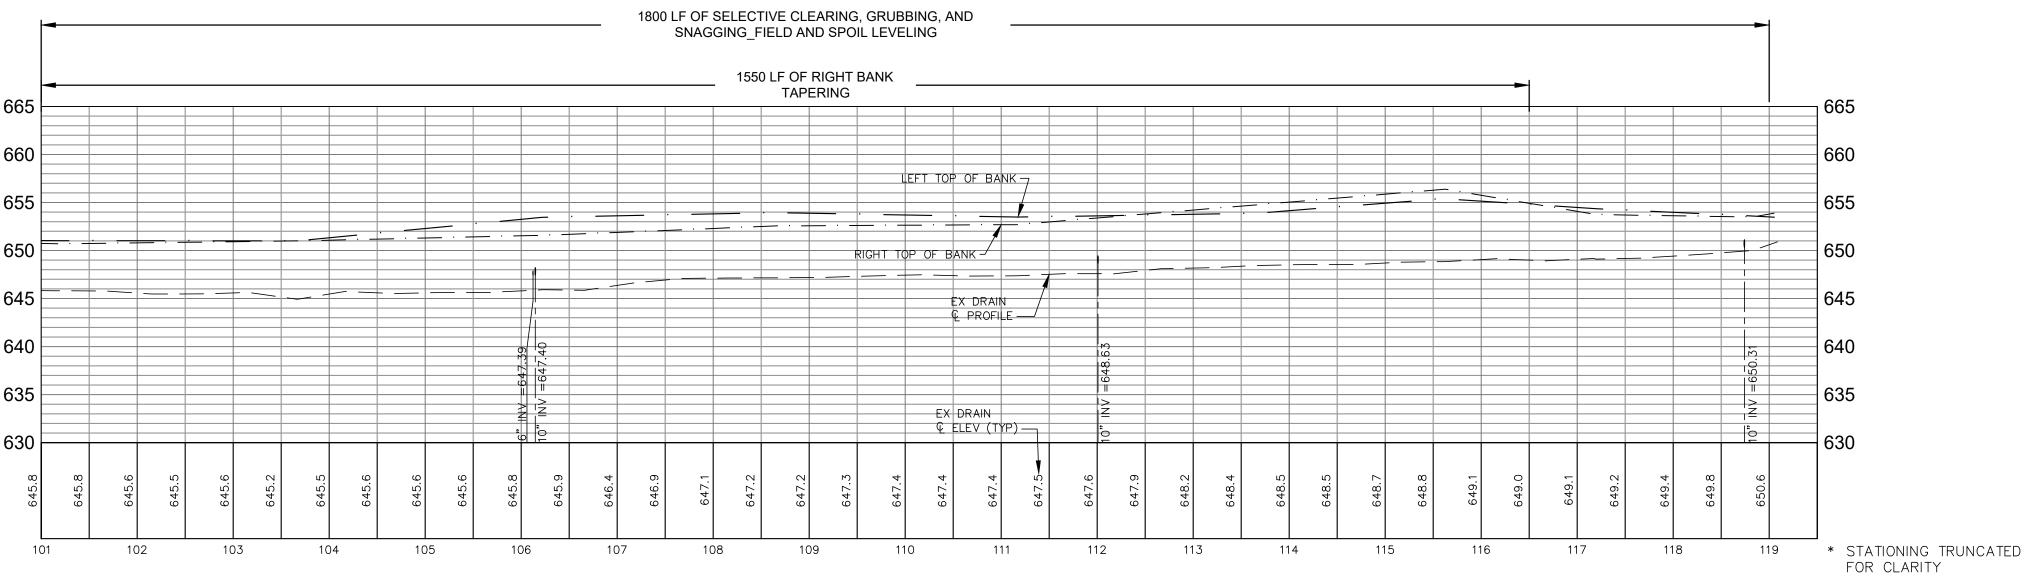


PROJECT NO. 23011

SHEET NO.

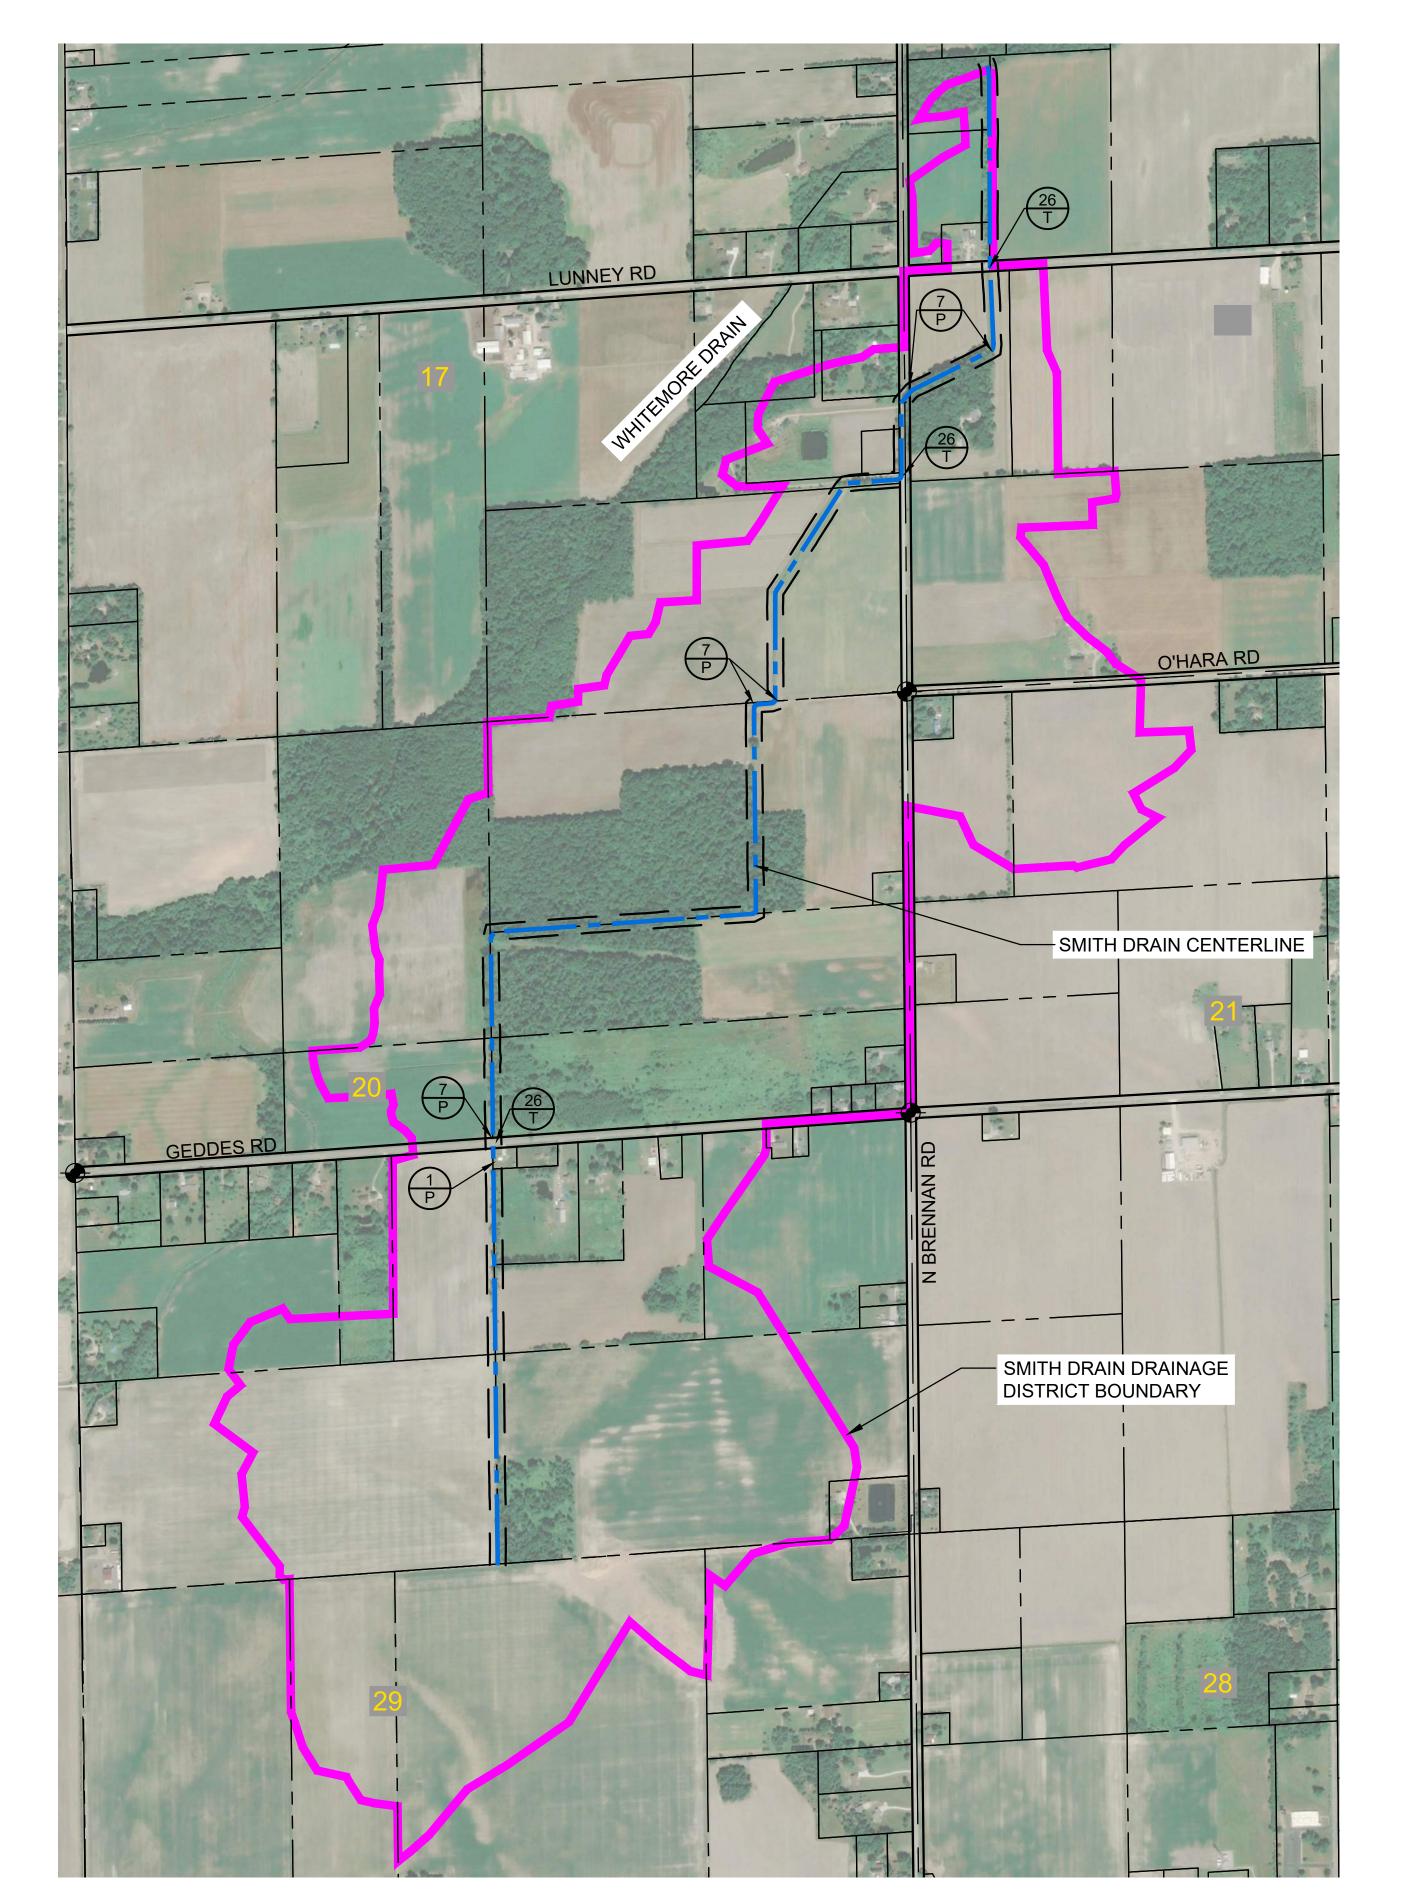



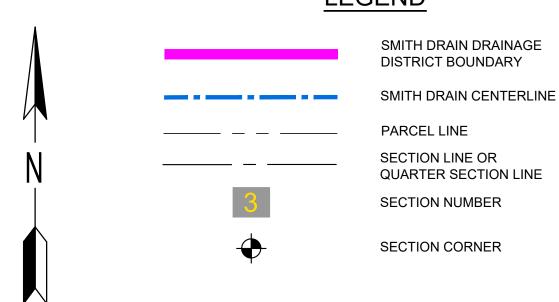

SCALE: 600'

EROSION CONTROL MEASURES

| | | | TOE ME/TOOTTEO |
|----|-----------------------|----------------------|--|
| 1 | SEEDING | Manage of the second | When bare soil is exposed, temporarily or permanently, to erosive forces from wind and or water on flat areas, mild slopes, grassed waterways and spillways, diversion ditches and dikes, borrow and stockpile areas, and spoil piles. |
| | | | |
| 6 | SOIL BINDING POLYMERS | Erosion Control | Over all exposed soil surfaces or prepared seed beds that need protection from precipitation impact, sheet flow, rill flow or wind prior to erosive force impact. |
| | | | |
| 7 | RIPRAP | | Along drain banks, shorelines, or where concentrated flows occur. Slows velocity, reduces erosion and sediment load. |
| | | | |
| 26 | DUST CONTROL | | As a temporary measure on exposed and unstabilized areas that must be protected from wind or water erosion. |
| | | | |
| 63 | SEDIMENT SUMP (TRAP) | | When working in the drain, or drain easement and the soil disturbance and anticipated sediment is limited. |

CONSTRUCTION & SOIL EROSION AND SEDIMENTATION CONTROL NOTES:

- 1. ALL TEMPORARY SOIL EROSION AND SEDIMENTATION CONTROL MEASURES SHALL BE IN PLACE BEFORE CONSTRUCTION BEGINS. THE CONTRACTOR IS RESPONSIBLE FOR INSPECTING ALL MEASURES AT LEAST ONCE EACH WEEK AND/OR WITHIN 24 HOURS OF A PRECIPITATION EVENT THAT RESULTS IN STORM WATER RUNOFF OR DISCHARGE.
- 2. SURFACE RESTORATION OF ALL SEWER TRENCHES IN LAWN AREAS SHALL BE TOP SOILED AND SEEDED WITHIN 5 CALENDAR DAYS OF BACKFILLING THE TRENCH.
- 3. THE CONTRACTOR SHALL BE RESPONSIBLE FOR DUST CONTROL AND SHALL PROVIDE ALL EQUIPMENT AND MATERIAL NECESSARY TO KEEP DUST IN CHECK AT ALL TIMES. THE CONTRACTOR SHALL RESPOND IMMEDIATELY TO ANY AND ALL COMPLAINTS. STREETS, PARKING LOTS, DRIVEWAYS, PAVED ACCESS ROADS, AND ALL OTHER PAVED SURFACES SHALL BE SWEPT AT LEAST ONCE A DAY AND/OR AS NEEDED THROUGHOUT THE DAY.
- 4. ALL TEMPORARY SOIL EROSION MEASURES SHALL BE REMOVED AFTER PERMANENT MEASURES HAVE BEEN ESTABLISHED.
- 5. ALL CONSTRUCTION SHALL BE CONFINED TO AREAS OF DISTURBANCE WITHIN THE ROAD RIGHT OF WAY AND/OR WITHIN STORM SEWER EASEMENTS. NO WORK, MATERIAL, OR STOCKPILES WILL BE ALLOWED OUTSIDE OF THESE LIMITS.
- 6. ALL TRENCHES SHALL BE BACKFILLED TO GRADE OR PROPERLY PROTECTED IN ACCORDANCE WITH PROJECT PLANS & SPECIFICATIONS AT THE END OF EVERY DAY. AT NO TIME SHALL A TRENCH BE LEFT OPEN FOR A PERIOD LONGER THAN 48 HOURS.
- 7. PROTECT ALL TREES AND VEGETATION NOT SCHEDULED TO BE REMOVED. ENGINEER APPROVAL IS REQUIRED FOR ANY UNSCHEDULED REMOVAL OF TREES, SHRUBS OR LANDSCAPING.
- 8. EROSION AND SEDIMENTATION FROM WORK ON THIS PROJECT SHALL BE CONTAINED WITHIN THE WORK AREA AND NOT ALLOWED TO COLLECT ON OFF-SITE AREAS OR IN WATERWAYS - WATERWAYS INCLUDE BOTH NATURAL AND MAN-MADE OPEN DITCHES, STREAMS, STORM DRAINS, LAKES AND PONDS.

SESC NOTES

GENERAL MAINTENANCE

 TEMPORARY SESC MEASURES TO BE MAINTAINED BY THE CONTRACTOR AT ALL TIMES.

COMPLIANCE WITH PART 91 OF PA 451

- RESPOND IMMEDIATELY TO STORMWATER OPERATOR AND/OR SOIL EROSION AND SEDIMENTATION CONTROL INSPECTOR CONCERNS. MAKE CORRECTIVE
- MEASURES AS REQUIRED

CONTINUED MAINTENANCE PLAN

 STORMWATER OPERATOR/APA OWNER OR MAINTENANCE SUPERVISOR WILL INSPECT MONTHLY THROUGH THE FIRST GROWING SEASON. NON ESTABLISHED VEGETATION WILL BE REPAIRED/RESEEDED AS NECESSARY

| APPROXIMATE CONSTRUCTION SCI | HEDULE | FOR SE | SC ME | ASURES | | | , |
|--|--------|--------|--------|--------|--------|--------|--------|
| SESC - CONSTRUCTION SEQUENCE | WEEK 1 | WEEK 2 | WEEK 3 | WEEK 4 | WEEK 5 | WEEK 6 | WEEK 7 |
| INSTALL TEMPORARY SESC MEASURES: | | | | | | | |
| A. STABILIZED CONSTRUCTION ACCESSES | | | | | | | |
| B. CONSTRUCTION/TREE PROTECTION FENCE | | | | | | | |
| C. SEEDING | | | | | | | |
| MAINTAIN TEMPORARY SESC MEASURES | | | | | | | |
| SITE GRADING | | | 1 | | | | |
| OPEN DRAIN CONSTRUCTION | | | | | | | |
| CULVERT CONSTRUCTION | | | | | | | |
| FINAL GRADE | | | | | | | |
| FINAL SITE STABILIZATION (TO BE COMPLETED WITHIN 24 HOURS OF FINAL GRADING OR ACTIVITY WITHIN THAT AREA) | | | | | | | |
| REMOVE TEMPORARY SESC MEASURES | | | | | | | |
| PERMANENT SESC MEASURES | | | | | | | |

= PERMANENT MEASURE # = TEMPORARY MEASURE




PROJECT NO. 23011

SHEET NO.

8 of 9

SOIL EROSION AND SEDIMENTATION CONTROL

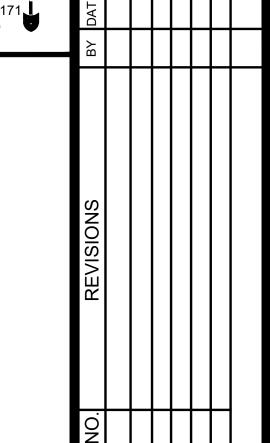



BRIAN WENDLING
COUNTY PUBLIC WORKS COMMISSIONER

PROJECT NO.

SAGINAW

SHEET NO.


23011

9 OF

ALIGNED WITH - CENTERLINE OF ALIGNED WITH - TOP OF RIPRAP IS FLUSH PROPOSED | CULVERT CENTERLINE OF FLOW FLOW LINE WITH EXISTING SURFACE AND RIPRAP THICKNESS IS **EQUAL TO THE MAXIMIUM ROCK SIZE** - CULVERT INVERT RECESSED (0.1 x HIEGHT)" CULVERT WIDTH <= 2': 2' OR 6" WHICH EVER IS LESS CULVERT LENGTH CULVERT WIDTH > 2': 5' TOP WIDTH - PROPOSED RIPRAP SEE PLANS FOR SYD ALIGNED WITH CENTERLINE OF → ALIGNED WITH CENTERLINE OF FLOW RIPRAP MUST BE FLUSH WITH BANK AND DRAIN BOTTOM PROPOSED CULVERT VARIES _____VARIES_

CHANNEL AT LOW
POINTS IN ADJACENT
FIELD TO ALLOW
OVERLAND FLOW

CULVERT DETAIL
NO SCALE

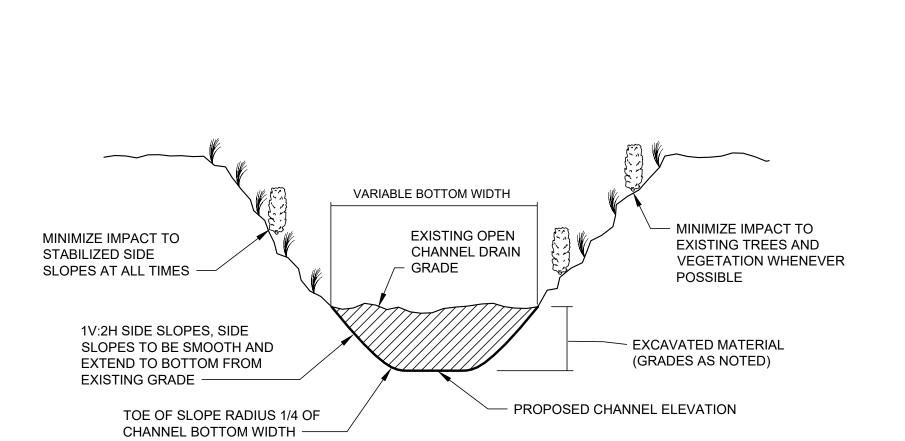

REMOVE ALL ASH TREES WITHIN EASEMENT-

APPLY GROWTH PREVENTER TO

2. STUMPS SHALL BE GRUBBED TO A

OR COVERED WITH 2-FEET OF


DEPTH OF 2-FEET BELOW GRADE

ALL EXPOSED STUMPS.

SPOIL MATERIAL.

NOTES:

OPEN DRAIN CLEANOUT DETAIL

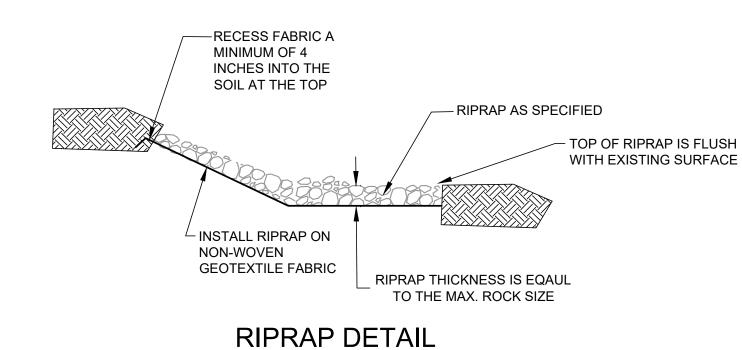

- IF PORTION OF TILE NEEDS TO BE REPLACED:

WITH MANUFACTURER SUPPLIED COLLAR.

- DRAIN BANK

MAX. 6"

FIELD TILE ADJUSTMENT

NO SCALE

CONTRACTOR SHALL PROVIDE 12" WIDE X 3" THICK

CONTRACTOR SHALL ATTACH NEW FIELD TILE OUTLET

- DO NOT DISTURB STABLE DITCH BANK IF

OUTLET TUBE IS NOT TO BE REPLACED.

- RODENT GUARD IF

EXISTING OUTLET

- MIN = 2 X MAX ROCK SIZE

- DRAIN BOTTOM

TOP OF RIPRAP IS

EXISTING SURFACE


FLUSH WITH

HAS ONE

TILE CLAY OR CONCRETE:

TILE OTHER MATERIAL:

CONCRETE COLLAR AT JOINT.

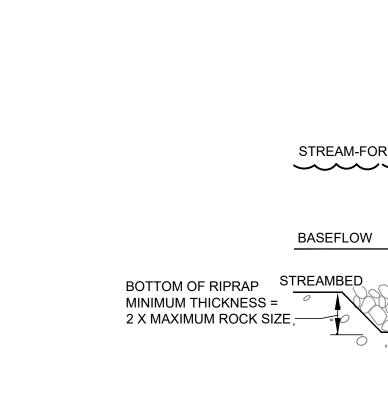

-DRAIN CENTERLINE


EASEMENT LIMITS

TOP OF BANK

SPOIL LEVELING DETAIL

NO SCALE

RIPRAP TOE OF SLOPE NO SCALE

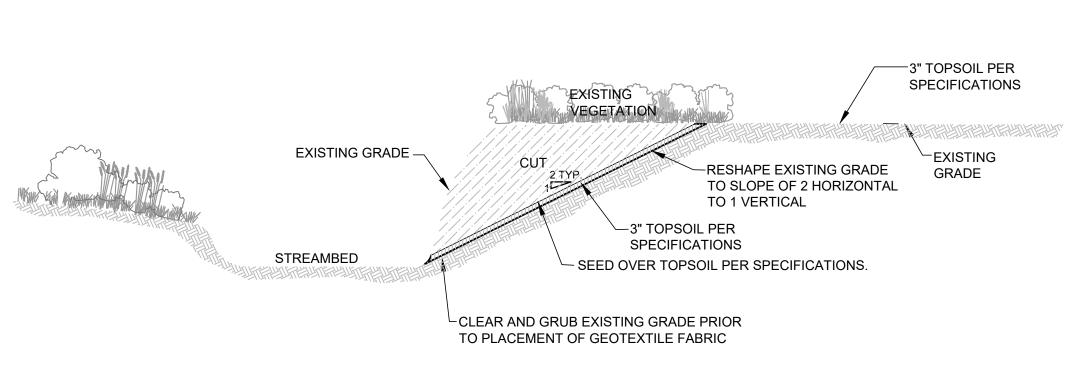

85 BANK TAPERING


EASEMENT AREA (IN OPEN AREA) CLEARING LIMITS (IN FORESTED AREA)

SPOIL PILE

CROSS SECTION-SPOIL LEVELING AREA

NO SCALE

EXISTING GRADE

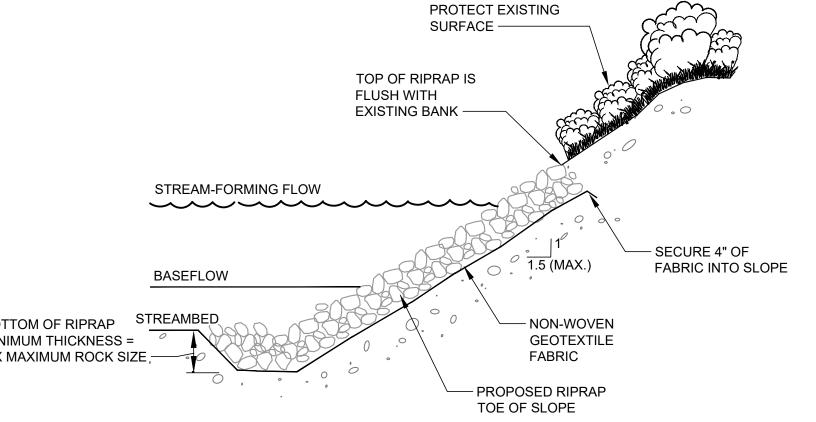

EXISTING

SECURE 4" OF

FABRIC INTO SLOPE

MIN = MAX ROCK SIZE

INSTALL RIPRAP ON

GEOTEXTILE FABRIC —

NON-WOVEN

TILE

— COMPLETE CLEARING WITHIN CHANNEL

INTERFERE WITH CONSTRUCTION

ALL TREES

W/ANGLES 30°

OR GREATER

SHALL BE CUT

SELECTIVE CLEARING,

GRUBBING & SNAGGING DETAIL

NO SCALE

CLEAR TO TOP OF BANK ON

NON-WORKING SIDE

NO CLEARING

SECTION, CUT STUMPS FLUSH WITH GROUND SURFACE AND LEAVE IN PLACE UNLESS THEY

COMPLETE CLEARING & GRUBBING

WITHIN EASEMENT ON WORKING SIDE

-REMOVE SNAGS,

DEADFALL AND OTHER DEBRIS

FROM CHANNEL